DATE REVISED	DATE FILMED	DATE REVISED	DATE FILMED	FED.ROAD DIST.NO.	STATE	FED.AID PROJ.NO.	SHEET NO.	TOTAL SHEETS
				6	ARK.			
				JOB	NO.]	


ARKANSAS STATE HIGHWAY & TRANSPORTATION DEPARTMENT CONSTRUCTION PLANS FOR

4 PUBLIC TRANSPORTATION PARKING LOT & DEMONSTRATION BUILDING (LR)(S)


PUBLIC TRANSPORTATION PARKING LOT & DEMONSTRATION BUILDING (LR)(S)


AHTD JOB NO. 061421 FTA JOB NO. F729 FTA GRANT NO. AR-18-X029

ROUTE 338 SECTION 1 PULASKI COUNTY

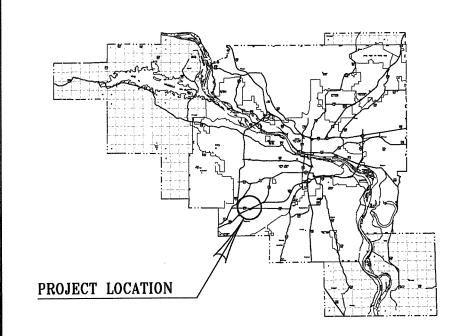

VICINITY MAP

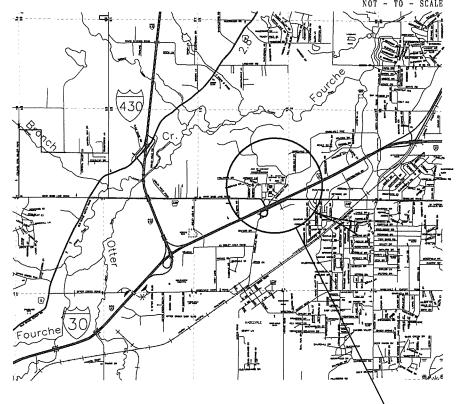

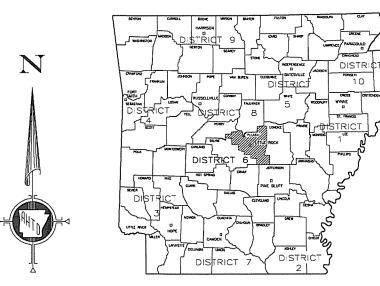

PULASKI COUNTY

PROJECT LOCATION

MIDPOINT OF PROJECT

LONGITUDE 92° 23' 00" LATITUDE 34° 40' 15" I hereby certify that these plans and specifications have been prepared by me, or under my supervision. I further certify that to the best of my knowledge these plans and specifications are as required by law and in compliance with the Arkansas Fire Prevention Code for the State of

 Chais
 East
 01 / 27 / 201

 Christopher East, AIA
 Date

CROMWELL ARCHITECTS ENGINEERS, INC. Architects Engineers 101 S. Spring Street Little Rock, Arkansas C-98
REGISTERED REGIST







ARKANSAS STATE HIGHWAY AND TRANSPORTATION DEPARTMENT PARKING LOT & DEMONSTRATION BUILDING



ARCHITECT OF RECORD

101 south spring street little rock, ar 72

Issue Date
27-JANUARY-2014
Project Number 2012-102.
Drawing Title
TITLE SHEET

Drawing Number

G-001



CONSTRUCTION DATA

PROJECT NAME: ARKANSAS HIGHWAY AND TRANSPORTATION DEPARTMENT PUBLIC TRANSIT OFFICE ADDITION

I-30, LITTLE ROCK, AR

BUILDING AREA: NEW CONSTRUCTION: 1,024 SF

OCCUPANCY: BUSINESS (B)

ADDRESS:

CONSTRUCTION TYPE: 2B, NON SPRINKLERED

OWNER: STATE OF ARKANSAS

ALL REQUIRED TESTING AND INSPECTION WILL BE PAID FOR BY THE CONTRACTOR.

GOVERNING SPECIFICATIONS

ARKANSAS STATE HIGHWAY COMMISSION STANDARD SPECIFICATIONS FOR HIGHWAY CONSTRUCTION. EDITION OF 2014, AND THE FOLLOWING SUPPLEMENTAL SPECIFICATIONS AND

NUMBER TITLE
ERRATA ---- ERRATA FOR THE BOOK OF STANDARD SPECIFICATIONS
JOB 061421 -- BUILDER'S RISK INSURANCE

JOB 061421 - - COMPETENCY OF BIDDERS

JOB 061421 - - FTA CERTIFICATION AND ASSURANCES
JOB 061421 - - GOALS FOR DISADVANTAGED BUSINESS ENTERPRISE PARTICIPATION
JOB 061421 - - INTERNET BIDDING

JOB 061421 - - PROJECT MANUAL

JOB 061421 - - STANDARD SPECIFICATIONS APPLICABILITY

SP 108-1 - - - LIQUIDATED DAMAGES

	SUMMARY OF QUANTITIES		
ITEM NO.	TITLE	QUANTITY	UNIT
1	BUILDING, PARKING LOT AND SITE WORK COMPLETE	1	LS
2	MOBILIZATION	1	LS

	REVISION BLOCK					
DATE	REVISION					
4/07/2014	ADDENDA 001, CHANGING THE FOLLOWING SHEETS G-101, CS-101, CU-101, A-101, E-601					

		SHEET INDEX		
NO.	DRAWING NO.	TITLE	REVISION NO.	DATE
1	G-001	TITLE SHEET		1/27/2014
2	G-101	INDEX AND CODE ANALYSIS	ADD 001	4/07/2014
3	GI101	LIFE SAFETY PLAN		1/27/2014
4	V-101	SITE SURVEY		1/27/2014
5	CS-101	SITE LAYOUT PLAN	ADD 001	4/07/2014
6	CS-501	SITE DETAILS		1/27/2014
7	CS-502	SITE DETAILS		1/27/2014
8	CG-101	SITE GRADING AND DRAINAGE PLAN		1/27/2014
9	CG-501	SITE DETAILS		1/27/2014
10	CG-701	SITE EROSION AND SEDIMENTATION CONTROL PLAN		1/27/2014
11	CG-702	SITE EROSION AND SEDIMENTATION CONTROL DETAILS		1/27/2014
12	CU-101	SITE UTILITY PLAN	ADD 001	4/07/2014
13	CU-501	SITE DETAILS		1/27/2014
14	S-001	STRUCTURAL QUALITY CONTROL		1/27/2014
15	S-002	STRUCTURAL QUALITY CONTROL		1/27/2014
16	S-003	GENERAL NOTES		1/27/2014
17	S-101	FOUNDATION PLAN		1/27/2014
18	S-201	FOUNDATION DETAILS		1/27/2014
19	S-301	BLOCK DETAILS		1/27/2014
20	S-302	BLOCK DETAILS		1/27/2014
21	S-401	FRAMING PLAN		1/27/2014
22	S-501	FRAMING DETAILS		1/27/2014
23	A-001	MOUNTING HTS., ABBREVIATIONS AND SYMBOLS		1/27/2014
24	A-002	PARTITION SCHEDULE		1/27/2014

NO.	DRAWING NO.						
25	A-101	FLOOR PLANS AND INTERIOR ELEVATIONS	ADD 001	4/07/201			
26	A-102	ROOF PLANS AND DETAILS		1/27/201			
27	A-201	EXTERIOR ELEVATIONS		1/27/201			
28	A-301	BUILDING SECTIONS / INTERIOR ELEVATIONS		1/27/201			
29	A-401	WALL SECTIONS		1/27/20			
30	A-402	WALL SECTIONS		1/27/20			
31	A-501	EXTERIOR DETAILS		1/27/20			
32	A-502	EXTERIOR DETAILS		1/27/20			
33	A-503	ROOF DETAILS		1/27/20			
34	A-504	EXTERIOR DETAILS		1/27/20			
35	A-601	INTERIOR ELEVATIONS AND SCHEDULES		1/27/20			
36	P-001	PLUMBING LEGEND AND GENERAL NOTES		1/27/20			
37	P-101	PLUMBING PLAN AND RISER		1/27/20			
38	P-501	PLUMBING DETAILS		1/27/20			
39	P-601	PLUMBING SCHEDULES		1/27/20			
40	M-001	MECH. ABBREV'S, LEGENDS AND GEN. NOTES		1/27/20			
41	M-101	MECHANICAL PLAN		1/27/20			
42	M-501	MECHANICAL DETAILS		1/27/20			
43	E-001	ELECTRICAL LEGEND		1/27/20			
44	E-101	ELECTRICAL PLANS		1/27/20			
45	E-501	ELECTRICAL DETAILS		1/27/20			
46	E-601	SINGLELINE DIAGRAM AND SCHEDULES	ADD 001	4/07/20			
47							
48							
49							







PARKING LOT & DEMONSTRATION BUILDING ARKANSAS STATE HIGHWAY AND TRANSPORTATION DEPARTMENT



101 south spring street little rock, ar 72201 501,372,2900 cromwell,com

Issue Date 27-JANUARY-2014

INDEX AND CODE **ANALYSIS**

G-101

Current Arkansas Building Codes:

Arkansas Fire Prevention Code 2007 Volume | International Fire Code 2006

Volume II International Building Code 2006

Arkansas Plumbing Code 2007 International Plumbing Code 2006

Arkansas Mechanical Code 2010 International Mechanical Code 2009

Arkansas Electric Code 2012 National Electric Code 2011

Arkansas Energy Code 2011

ASHRE 90.1 2001 (Changes to 2007 edition on January 2013)

ADA Accessibility Guidelines / ANSI A117.1

OCCUPANCY: (Chapter 3)

Business per Section 304

S Storage per Section 304 (less than 100 SF)

HEIGHT AND AREA: (Chapter 5)

CONSTRUCTION CLASSIFICATION: Type IIB Non Sprinkled

TABULAR HEIGHT & AREA (TABLE 503):

23,000 sf Per Floor 4 stories

ACTUAL HEIGHT & AREA (TABLE 503):

1,024 sf (New Building)

1 story

55 ft.

16'-0"

FIRE ALARM SYSTEM IS NOT REQUIRED BY CODE, HOWEVER IT IS BEING INSTALLED BASED ON **OWNER'S REQUEST**




B-BUSINESS



S-1 - STORAGE

NO RATED WALL **ASSEMBLIES** REQUIRED

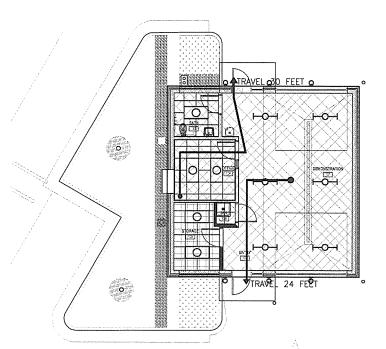

NEW PARKING LOT & DEMONSTRATION BUILDING



LIFE SAFETY PLAN

The Training Room is an Accessory Assembly area, but is not considered a separate occupancy because it is less than 750 s.f. per 508.3.1, Exception 1

The Storage Room is being considered as an incidental use area to the Business occupancy. It is over 100 s.f. and must have 1 hour separation per Table 508.2

TYPE OF CONSTRUCTION (Chapter 6)

BUILDING ELEMENT (from Table 601 & 602)	REQUIRED RATING Type IIB
Structural Frame Including columns, girders, trusses	0 hour
Bearing Walls Exterior Interior	0 hour 0 hour
NonBearing Walls and Partitions Exterior Interior	0 hour 0 hour
Floor Construction Including support beams & joists	0 hour
Roof Construction Including support beams & joists	0 hour

Exterior wall adjacent to existing building is separated by greater than 10', so no fire rating is required per Table 602

FIRE PROTECTION (Chapter 7)

OPENING PROTECTIVE FIRE PROTECTION RATINGS (Per Table 714.2)

One Hour Fire Barriers require ¾ hr. opening protection assembly at incidental use separation per Table 715.4

MEANS OF EGRESS (Chapter 10)

ALLOWABLE EXIT TRAVEL DISTANCE (Per Table 1016.1) 200 Feet

OCCUPANT LOAD (Section 1004)

ROOM	AREA	SQ. FT. PER OCCUPANT	OCCUPANT LOAD
Business Occupancy	798 s.f.	100 gross	8
Storage	84 s.f.	300 gross	1
			9

ACCESSIBILITY (CHAPTER 11)

All provisions of the Americans with Disabilities Act shall be complied with whether or not they are incorporated into The Arkansas Fire Code and IBC 2006 with Arkansos Amendments.

ARKANSAS PLUMBING CODE

MINIMUM NUMBER OF REQUIRED PLUMBING FIXTURES (Table 403.1)

Water closets and urinals (REQUIRED): 1 per 25 (first 50); 1 per 50 (remainder) Required: 1 TOTAL

Lavatories (REQUIRED):

1 per 40 (first 80); 1 per 80 (remainder)

Required: 1 TOTAL

Drinking Fountains (REQUIRED): 1 per 100 [(9 / 100) = 1 total, and it must be wheelchair accessible]

Drinking Fountains (PROVIDED): 1 — HC accessible

Other: 1 service sink

ARKANSAS STATE HIGHWAY AND TRANSPORTATION DEPARTMENT



BUILDING

DEMONSTRATION

LOT

PARKING I


CROMWELL

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LIFE SAFETY PLAN

GI101

SCALE: 1/8" = 1'-0"

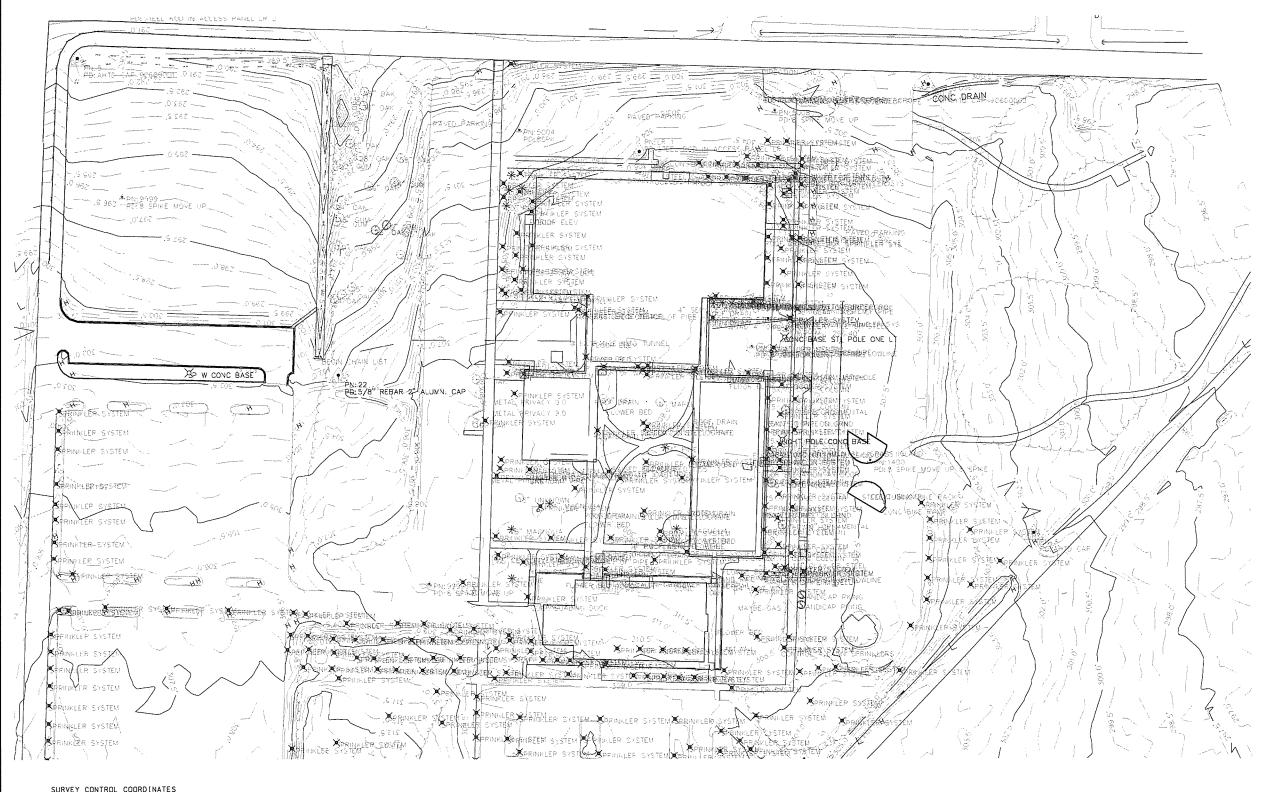

SURVEY CONTROL COORDINATES


Project Name: s061045
Date: 11/21/2012
Coordinate System: ARKANSAS STATE PLANE -SOUTH ZONE BASED ON GPS CONTROL,
PROJECTED TO GROUND.
Units: U.S. SURVEY FOOT

Point Name	Northing	Easting	Elev	Feature	Description
LR 1 LR 2 3 5 6 7 20 21 22	2042602.2213 2042759.5809 2042202.3323 2042700.4640 2042672.2586 2042097.8373 2042596.8060 2041964.0439 2042368.3532	1197363.9755 1196826.2803 1197773.8930 1196778.3026 119665.1758 1198521.5786 1198120.5495 1197534.2856 1197049.9345	304.58 290.35 301.92 291.55 300.89 286.82 295.46 306.57 302.24	GPS GPS GPS GPS GPS CTL CTL	STEEL ROD IN ACCESS PANEL LR 1 STEEL ROD IN ACCESS PANEL LR 2 AHTD CAP 90600001 AHTD CAP 90600001 AHTD CAP 90600002 AHTD CAP 90600003 5/8" REBAR 2" ALUMN. CAP 5/8" REBAR 2" ALUMN. CAP 5/8" REBAR 2" ALUMN. CAP

*Note - Rebar and Cap - Standard - 5/8" Rebar with 2" Aluminum Cap stamped
*(standard markings common to all caps). or as indicated
(other markings indicated in the point description of the individual point).
ALL DISTANCES ARE GROUND:
USE CAF = 1.0 FOR STAKEDUT FOR THIS PROJECT.
A PROJECT CAF OF 0.99995239 HAS BEEN USED TO COMPUTE THE ABOVE GROUND COORDINATES.
THIS CAF IS INTENDED FOR USE WITHIN THE PROJECT LIMITS.
GRID DISTANCE - GROUND DISTANCE X CAF
GRID DISTANCE - GROUND DISTANCE X CAF
GRID COORDINATES ARE STORED UNDER FILE NAME.sO61045gi.ctl
HORIZONTAL DATUM: NAD 83 (1997)
VERTICAL DATUM: NAD 83 FOSITIONAL ACCURACY THIRD ORDER. UNLESS SPECIFIED OTHERWISE
AT A SPECIFIC POINT.

REFERENCE POINTS (1500 SERIES) ARE TO BE USED TO ESTABLISH CONTROL IF THE PRIMARY CONTROL POINTS LISTED ABOVE HAVE BEEN DESTROYED. REFERENCE POINTS ARE NOT TO BE USED FOR VERTICAL CONTROL

BASIS OF BEARING:
ARKANSAS STATE PLANE GRID BEARINGS -0302-SOUTH ZONE
DETERMINED FROM GPS CONTROL POINTS: LR-1 & LR-2
CONVERGENCE ANGLE: 0-12-50.8 LEFT/RIGHT AT LT:34-40-21.4 LG:092-22-57.2
GRID AZIMUTH = ASTRONOMICAL AZIMUTH - CONVERGENCE ANGLE.

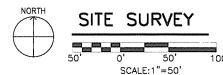

NOTE: SURVEY PROVIDED BY THE ARKANSAS STATE HIGHWAY AND TRANSPORTATION DEPARTMENT.

PARKING LOT & DEMONSTRATION BUILDING ARKANSAS STATE HIGHWAY AND TRANSPORTATION DEPARTMENT





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Issue Date 27-JANUARY-2014 2012-102_20

SITE SURVEY


V-101 4 of 46



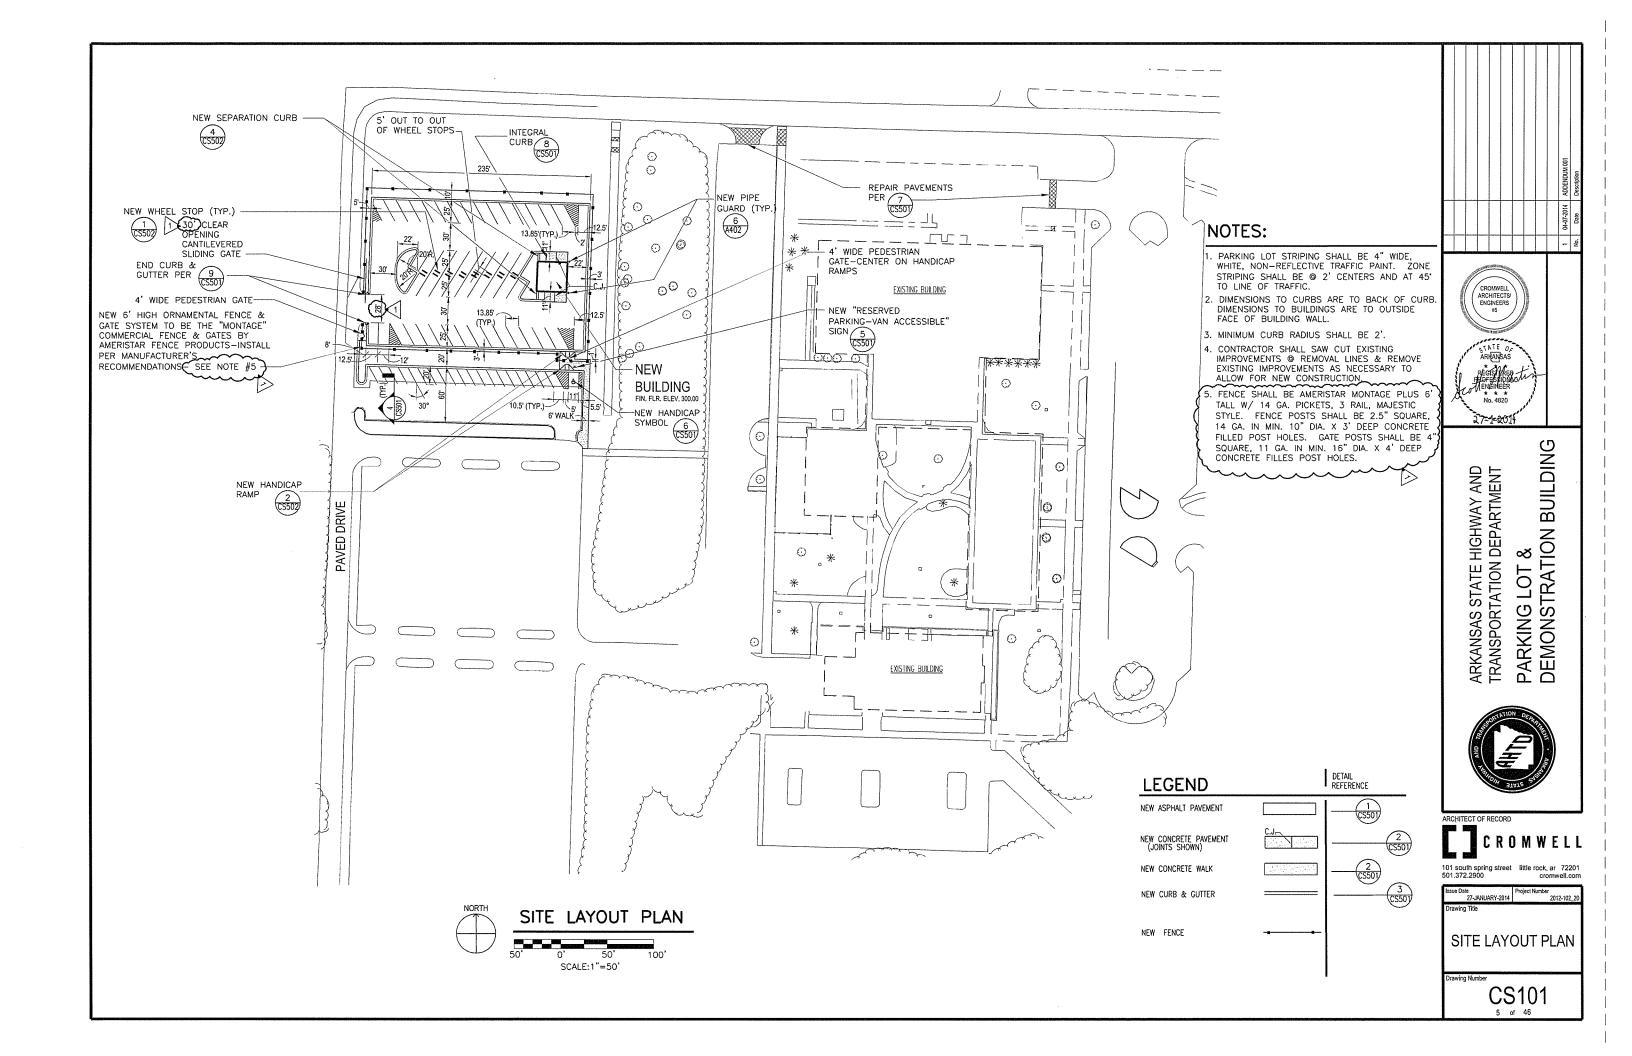

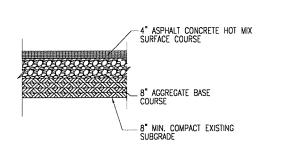ASPHALT PAVING DESIGN SECTION


NOT TO SCALE

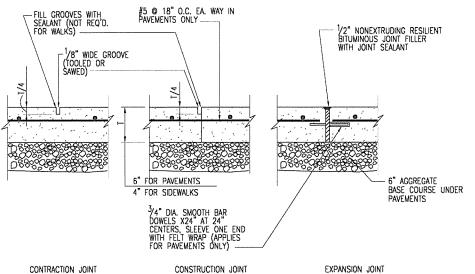


CONTRACTION JOINT EXPANSION JOINT NOTES:

- 1. FOR WALK CONSTRUCTION, SPACE JOINTS AT WALK WIDTH TO 8'
- 2. FOR WALKS 8' AND WIDER, SPACE JOINTS AT 1/2 WALK WIDTH AND USE \underline{c} C. JOINT ENTIRE LENGTH OF WALK.
- 3. FOR PAVEMENT CONSTRUCTION, SEE PLAN FOR JOINTING.
- SPACE E.J.'S FOR WALKS AT ALL ABUTTING CONSTRUCTION, AT CORNER RETURNS, AND AT EVERY 10TH. C.J.




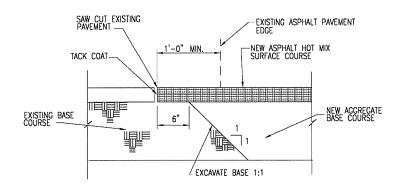

ASPHALT PAVEMENT JUNCTURE DETAIL

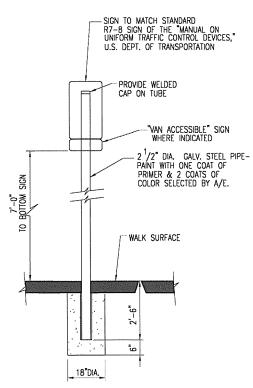


HANDICAPPED PARKING SIGN DETAIL

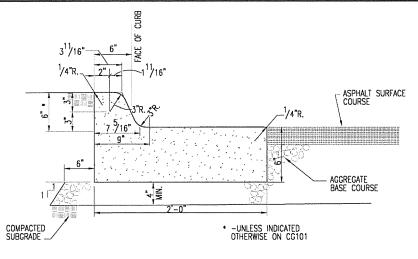

NOTE: CURB & GUTTER DETAILED IS THE AHTD TYPE A COMBINATION CURB & GUTTER

SAW CUT EXISTING


CURB & GUTTER DETAIL

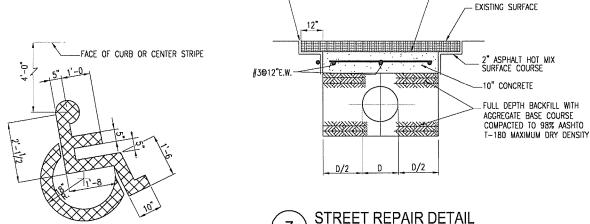

HANDICAP SYMBOL DETAIL


NOT TO SCALE

NOTE: SYMBOL TO BE PAINTED WITH WHITE NON-REFLECTIVE TRAFFIC PAINT

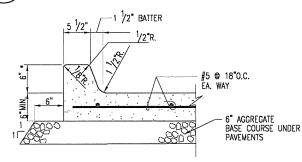

*-UNLESS INDICATED OTHERWISE ON CG101

INTEGRAL CURB DETAIL

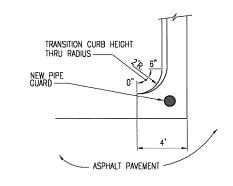

TACK COAT

END CURB & GUTTER DETAIL

NOT TO SCALE



BUILDING ARKANSAS STATE HIGHWAY AND TRANSPORTATION DEPARTMENT PARKING LOT & DEMONSTRATION




ARCHITECT OF RECORD CROMWELL

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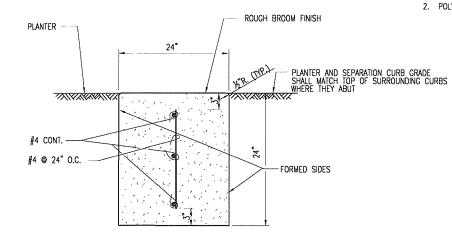
ssue Date Project Number 27-JANUARY-2014 SITE DETAILS

CS501

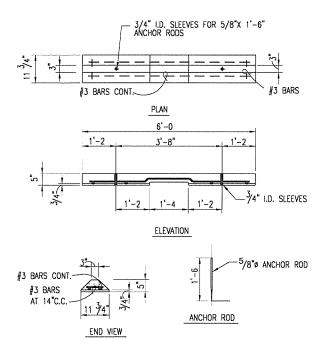


NOTE: APPROVED STANDARD MANUFACTURED WHEEL STOP MAY BE USED





SEPARATION CURB DETAIL

NOT TO SCALE

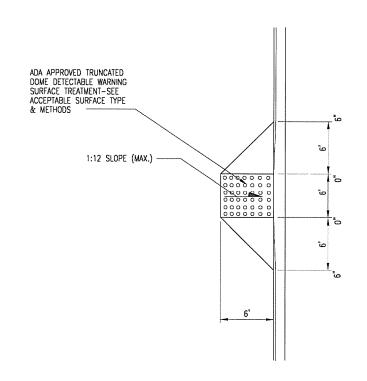

ACCEPTABLE SURFACE TYPES AND METHODS

- PATTERNED "STAMPED" CONCRETE:
 TRUNCATED DOME PATTERNED CONCRETE FORMED BY
 USING "STAMPCRETE" OR APPROVED EQUAL CONCRETE
 PATTERNING STAMP.
- 2. POLYURETHANE MAT AND ADHESIVE:


 POLYURETHANE TRUNCATED DOME WARNING MAT APPLIED
 WITH 2-PART ADHESIVE AS MANUF. BY/OR EQUAL:

 DETECTABLE WARNING SYSTEMS, INC.
 PMB 232
 17853 SANTIAGO BLVD., #107
 VILLA PARK, CA 92861
- RUBBER DOMES WITH POLYURETHANE COATING:
 "SAFTI-TRAX" DETECTABLE WARNING SYSTEM-RESILIENT
 RUBBER TRUNCATED DOMES BY COTE-L INDUSTRIES
 WITH NON-SLIP POLYURETHANE SAFETY COAT
 (OVERCOATING) AS MANUF. BY/OR EQUAL:

THE DURBAK COMPANY AURORA, CO 80014 PH. 303-690-7190

2 HANDICAP RAMP DETAIL

NOT TO SCALE

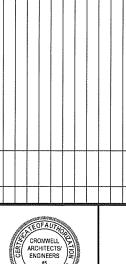



ARKANSAS STATE HIGHWAY AND TRANSPORTATION DEPARTMENT PARKING LOT & DEMONSTRATION BUILDING



ARCHITECT OF RECOR




101 south spring street little rock, ar 72201 501.372.2900 cromwell.com


Issue Date 27-JANUARY-2014 Project Number 2012-102 20


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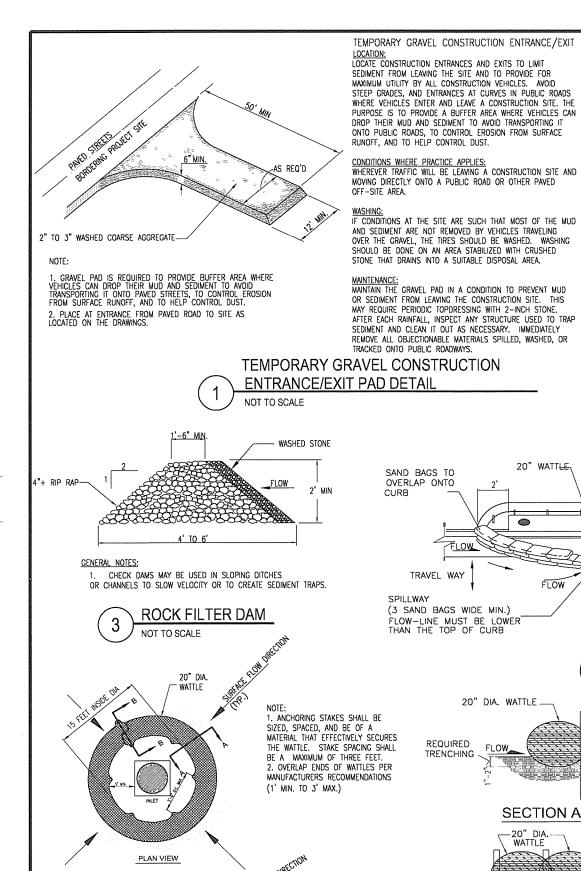
SITE DETAILS

CS502



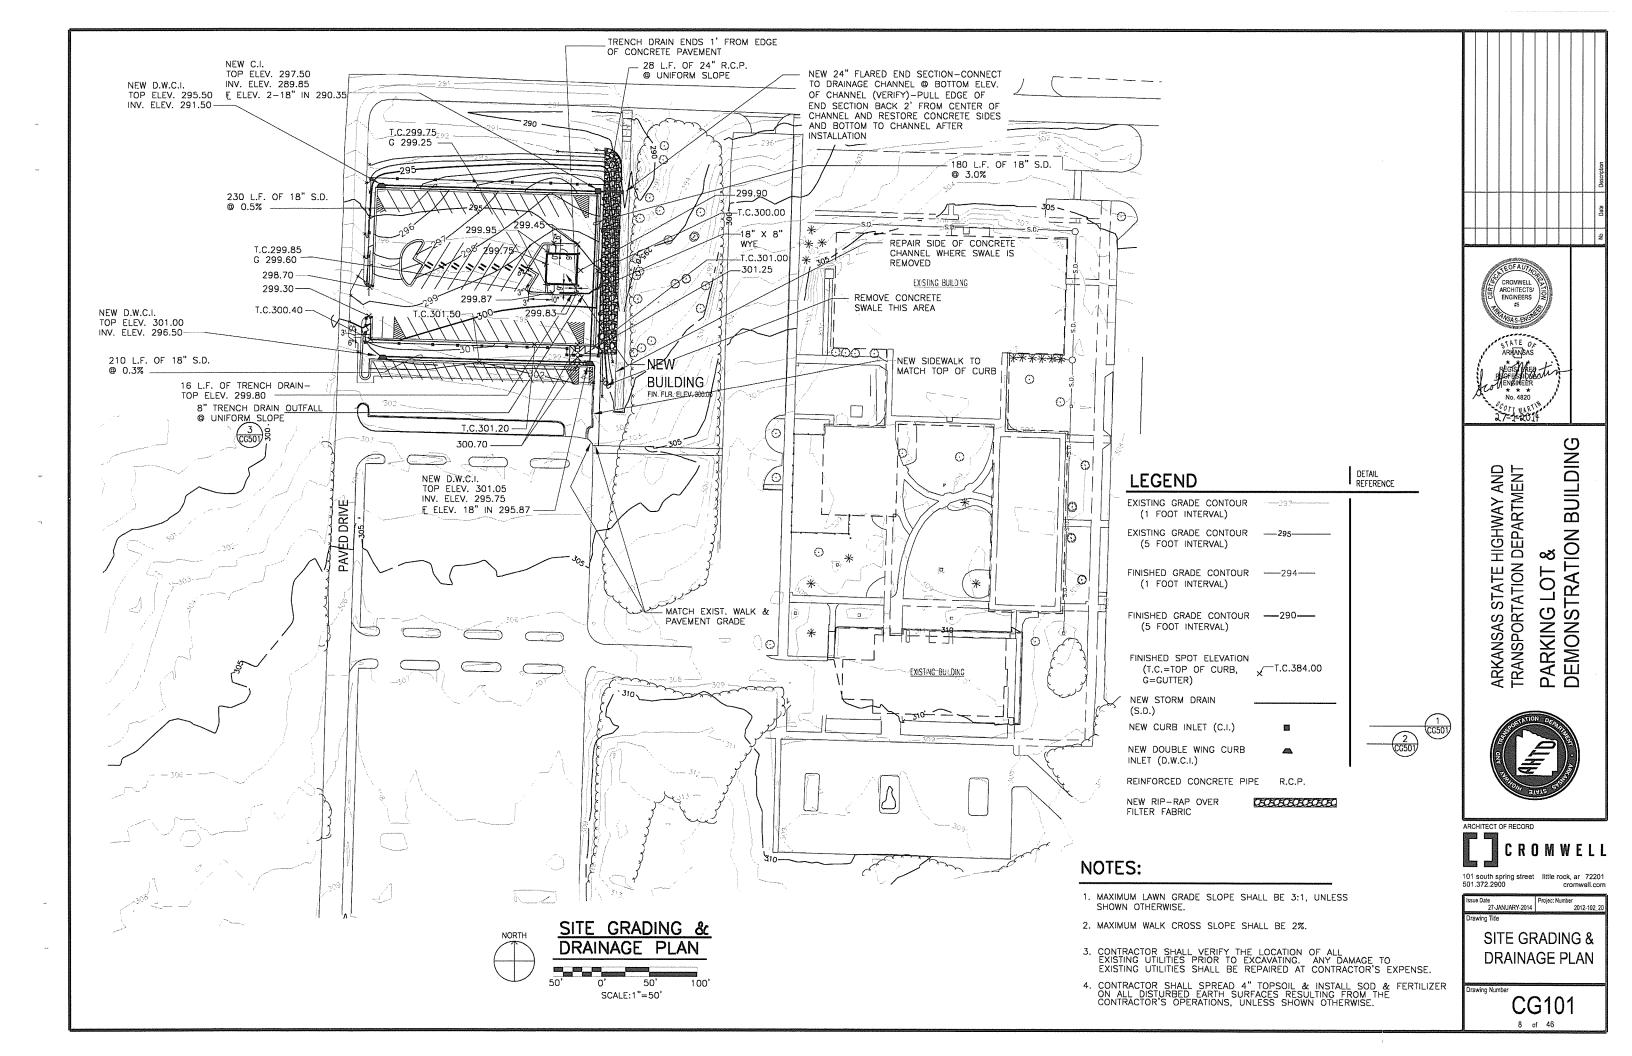


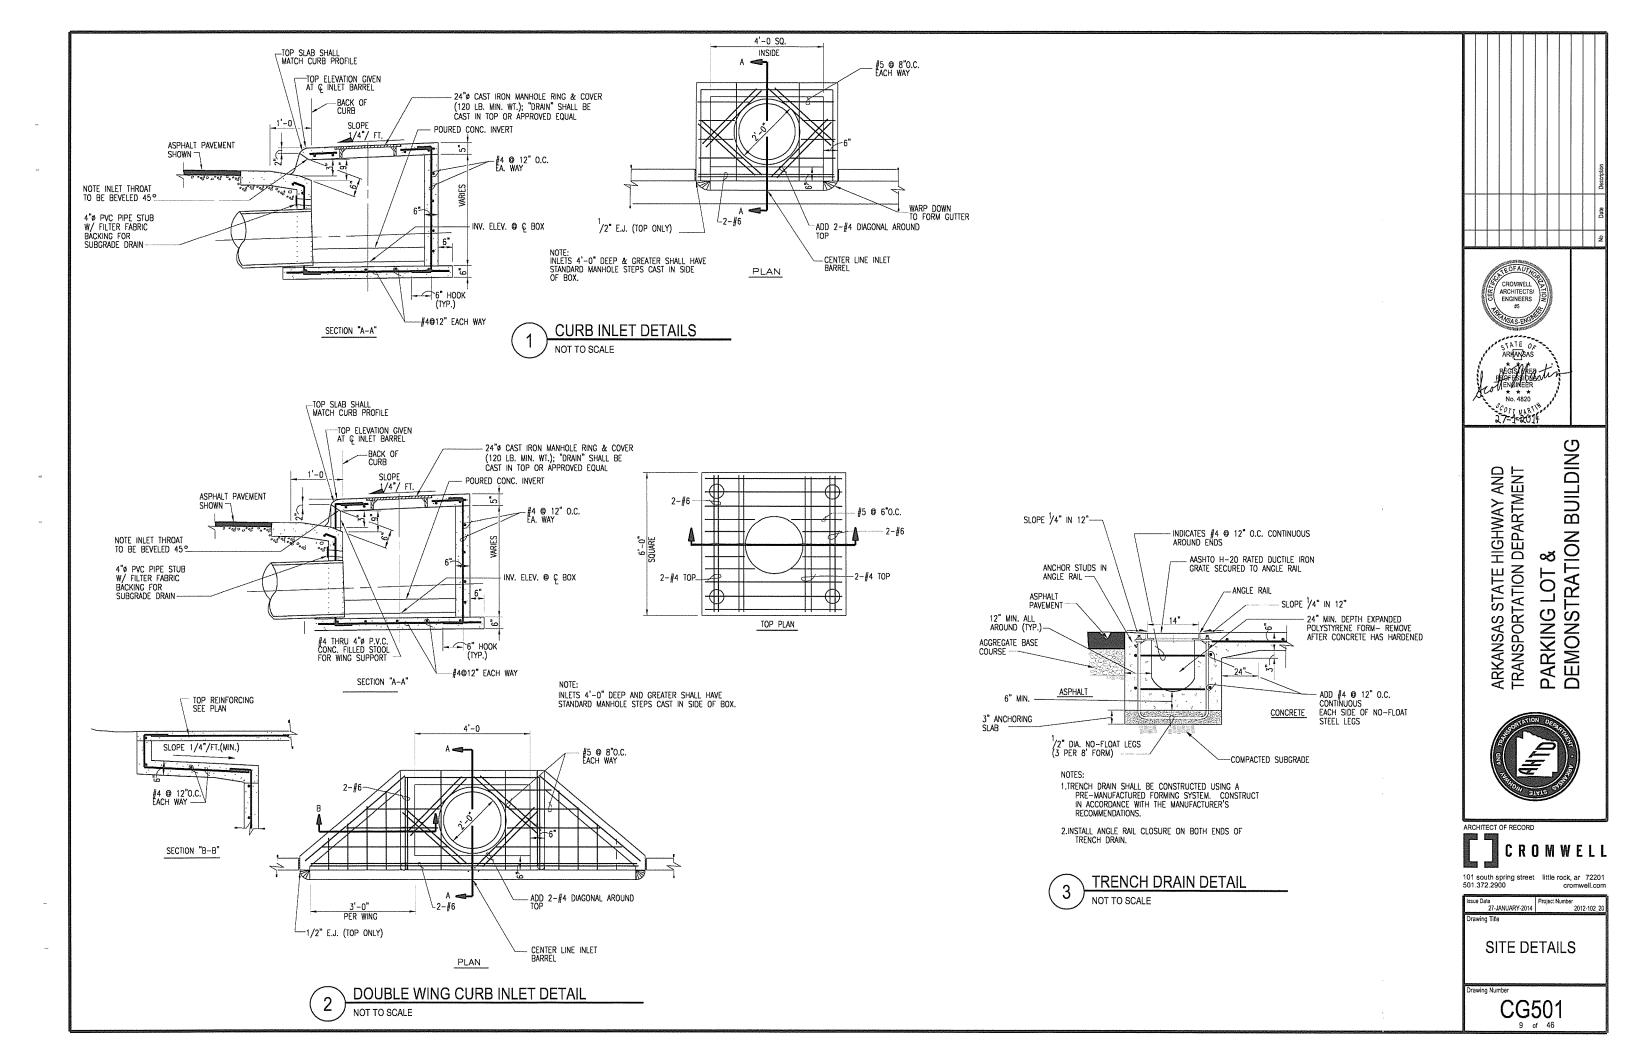

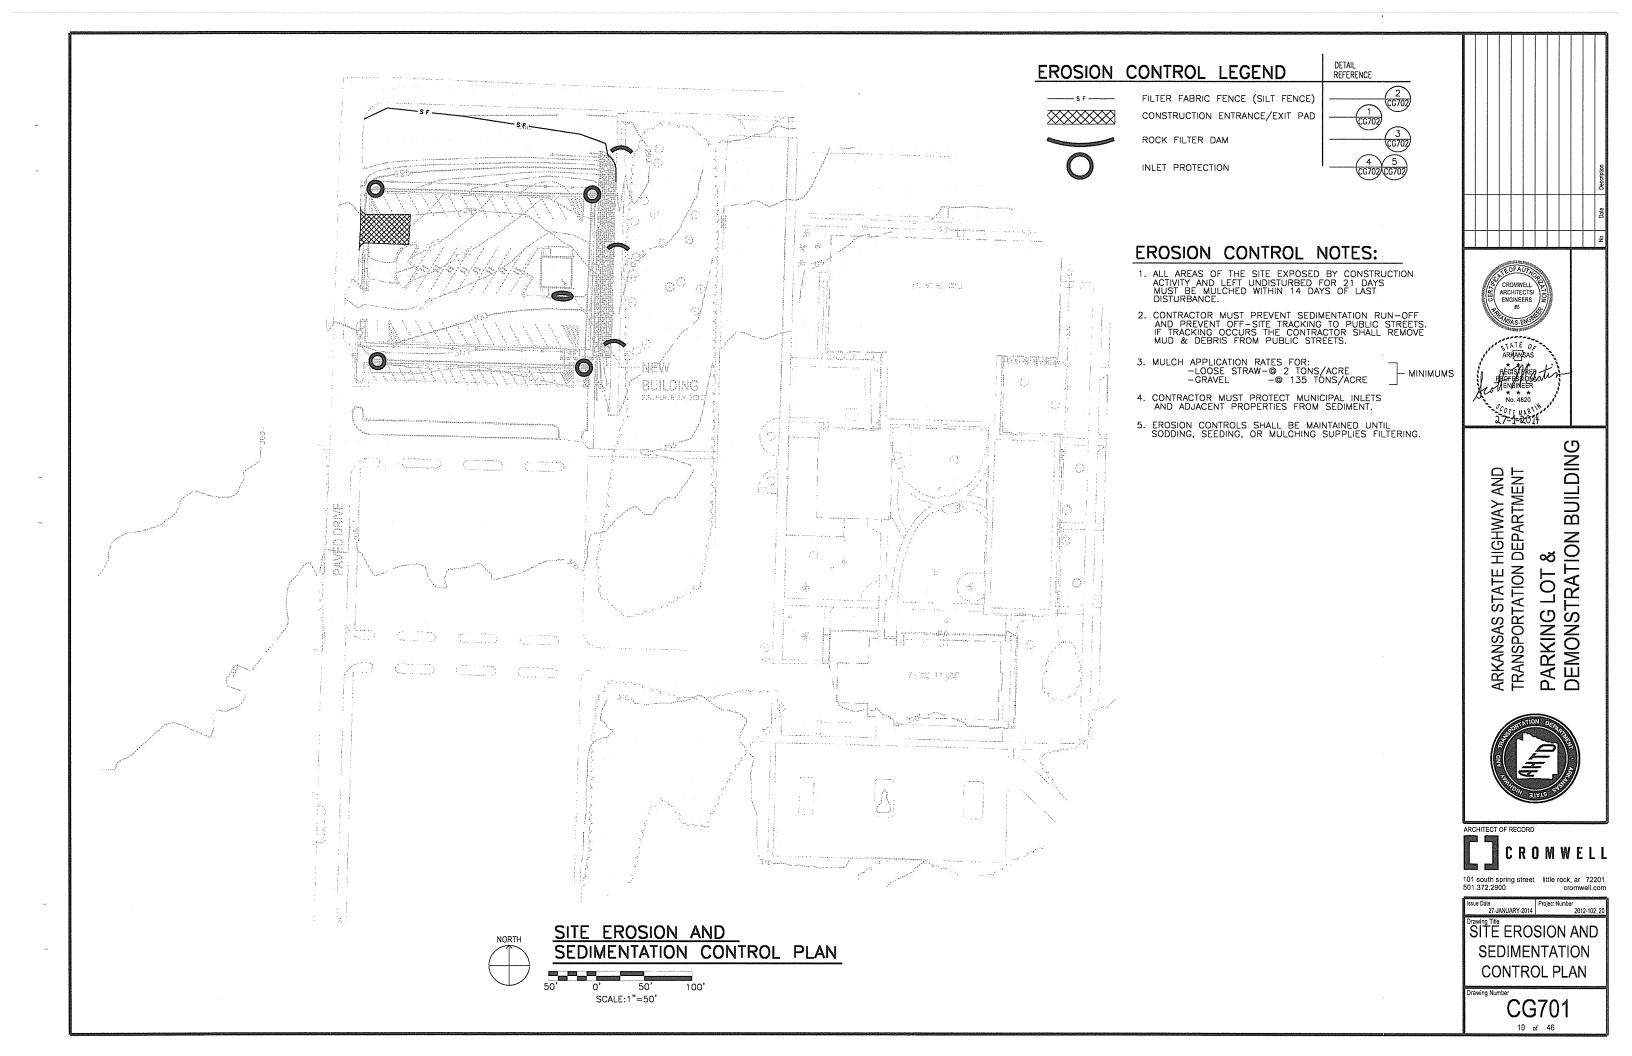

15' INSIDE DIA

-INLET

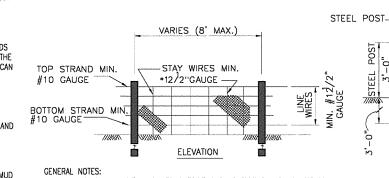

SILT FENCE SHALL BE INSTALLED OUTSIDE TOE OF EARTHFILL EMBANKMENTS. WIRE SHALL BE A MINIMUM OF 32" IN WIDTH AND SHALL HAVE A MIN. OF 6 LINE WIRES WITH 12" STAY SPACING

FILTER FABRIC SHALL BE A MINIMUM OF 36" IN WIDTH AND SHALL BE FASTENED SECURELY TO THE WIRE.

4. STEEL POSTS SHALL BE 6'-0" IN HEIGHT AND BE OF SELF-FASTENER 5. CONTRACTOR SHALL PERIODICALLY REMOVE ACCUMULATED SEDIMENT, AS

REQUIRED

THE FILTER FABRIC SHALL MEET THE FOLLOWING REQUIREMENTS: A) EOS IS NOT LARGER THAN U.S. STANDARD SIEVE NO.70 B) GRAB STRENGTH 90-120 LB C) CONFORM TO ASTM D-1682

TEMPORARY SEDIMENT FENCE DETAIL

REQUIRED

TRENCHING

-CURB & GUTTER OR

INTEGRAL CURB

SOIL LOSS CALCULATION

SUPPORT WIRE,

3'-0" MIN. WIDTH

FILTER FABRIC

FILL SLOPE

-GROUND LINE

FABRIC MIN. 8" DEEP

ANCHOR FILTER

FILTER FABRIC

SECTION

TEMPORARY SEDIMENT FENCE MAINTENANCE:

1) INSPECT SEDIMENT FENCES AT LEAST ONCE A WEEK AND AFTER EACH RAINFALL. MAKE ANY REQUIRED

2) SHOULD THE FABRIC OF A SEDIMENT

FENCE COLLAPSE, TEAR, DECOMPOSE OR BECOME INEFFECTIVE, REPLACE IT

3) REMOVE SEDIMENT DEPOSITS AS NECESSARY TO PROVIDE ADEQUATE STORAGE VOLUME FOR THE NEXT RAIN

AND TO REDUCE PRESSURE ON THE FENCE, TAKING CARE TO AVOID UNDERMINING THE FENCE DURING

4) REMOVE ALL FENCING MATERIALS AND UNSTABLE SEDIMENT DEPOSITS AND BRING THE AREA TO GRADE AND STABILIZE IT AFTER THE CONTRIBUTING

STAKE @ 3' O.C. MAX.

WITHOUT DAMAGE (TYP.)

-CHANNEL BOTTOM

DRAINAGE AREA HAS BEEN PROPERLY

STABILIZED.

SECTION A-A

20" DIA, WATTLE

FLOW

REMOVE ACCUMULATED SEDIMENT AFTER EVERY

RAINFALL. SWEEP SEDIMENT FROM HARD

SURFACES AND DISPOSE OF APPROPRIATELY AWAY FROM INLETS AND/OR WATER BODIES.

MIN. INTO GROUND STEP ONE: SITE EXCAVATION A. TOTAL SITE AREA = 1.81 ACRES B. DISTURBED AREA = 1.46 ACRES C. MAXIMUM VERTICAL CUT = 0 FEET D. QUANTITY OF EXCAVATION = 0 CUBIC YARDS E. THIS PROPERTY IS NOT LOCATED WITHIN THE 100-YEAR FLOODPLAIN BOUNDARY.

> STEP TWO: SOIL LOSS CALCULATION A. INITIAL SOIL LOSS CALCULATION 1. A = (R) * (K) * (LS) * (C) * (P)WHERE A = SOIL LOSS IN TONS PER ACRE PER YEAR (T/A/Y), R = 300, A CONSTANT IN PULASKI COUNTY, K = SOIL ERODIBILITY FACTOR FROM TABLE 10-1, LS = SLOPE LENGTH FACTOR FROM TABLE 10-2

C = COVER AND MANAGEMENT FACTOR FROM TABLE 10-3 AND TARIF 10-4 P = PRACTICE FACTOR FROM TABLE 10-5 AND

TABLES 10-1. 10-2, 10-3, 10-4, 10-5 AND 10-6 ARE FROM THE CITY OF LITTLE ROCK STORMWATER MANAGEMENT AND DRAINAGE MANUAL, REVISED 1992.

2. FROM THE SOIL SURVEY OF PULASKI COUNTY, THE SOIL ON THE SITE ARE IDENTIFIED AS: TUC

FROM TABLE 10-1, K=0.32 FOR TuC

3. SLOPE LENGTH: 234 FEET SLOPE : 3.4% AVERAGE LS =0..6356

4. FOR THE INITIAL CALCULATION, THERE IS NO COVER AND MANAGEMENT IN PLACE:

THEREFORE, C = 1

5. FOR THE INITIAL CALCULATION, THERE ARE NO CONTROL PRACTICES IN PLACE:

THEREFORE, P = 1

6. THE POTENTIAL SOIL LOSS FOR THIS SITE IS AS ANCHOR THROUGH NETTING

A = (R) * (K) * (LS) * (C) * (P)

A =61.018 T/A/Y IF LESS THAN 5.00 T/A/Y STANDARD ARE OKAY NO FURTHER CALCULATION IS NEEDED.

B. SINCE EROSION POTENTIAL EXCEEDS THE ALLOWABLE 5.00 T/A/Y, CONTROLS ARE WARRANTED

1. ALL DISTURBED SOIL LEFT IDLE FOR MORE THAN 21 DAYS WILL BE MULCHED WITH STRAW OR HAY AT A RATE OF 2 TONS PER ACRE. FROM TABLE 10-3,

C = 0.12 A = 7.3223 T/A/Y

2. DURING CONSTRUCTION AND UNTIL VEGETATION GROWTH IS EVIDENT FOLLOWING COMPLETION OF CONSTRUCTION, 50 FEET WIDE GRAVEL/STONE FILTER BERMS WILL BE USED FOR EROSION CONTROL. FROM TABLE 10-6,

P =0.50 A = 3.66 T/A/Y


3. UPON COMPLETION OF GRADING, A MINIMUM OF 60% OF THE SITE WILL BE SEEDED TO ESTABLISH A PERMANENT GRASS COVER. FROM TABLE 10-4.

C = 0.042 A = 2.56 T/A/Y

4. THE CONSTRUCTION PROCESS WILL TAKE NO LONGER THAN SIX MONTHS. ASSUMING THE SIX MONTH BLOCK WITH THE GREATEST RAINFALL ENERGY-INTENSITY PERCENTAGE OF THE RAINFALL WILL OCCUR, ACCORDING TO THE TABLE. THEREFORE, DURING THE YEAR OF CONSTRUCTION:

PERCENT OF YEARLY RAINFALL DURING PROJECTED CONSTRUCTION SCHEDULE = 54.45% (WORST CASE OF RAINFALL)

A =2.98 T/A/Y WHICH IS LESS THAN THE MAXIMUM ALLOWABLE OF 5.00 T/A/Y

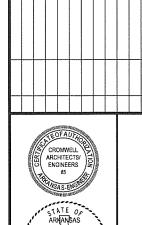

* * * No. 4820

27-1-201

BUILDING ARKANSAS STATE HIGHWAY AND TRANSPORTATION DEPARTMENT **EMONSTRATION** LOT PARKING



ARCHITECT OF RECORD



ue Date 27-JANUARY-2014 **SITE EROSION & SEDIMENTATION CONTROL DETAILS**

CG702 11 of 46

CATCH BASIN/TRENCH DRAIN PROTECTION

REQUIRED

TRENCHING

CURB INLET PROTECTION NOT TO SCALE

SAND BAGS

NOT TO SCALE

20" DIA. WATTLE STAKE @ 3' O.C. MAX. ANCHOR THROUGH NETTING WITHOUT DAMAGE (TYP.) - CHANNEL BOTTOM REQUIRED FLOW TRENCHING

20" WATTLE

TRAVEL WAY


SECTION A-A 20" DIA. WATTLE STAKE @ 3' O.C. MAX. WITHOUT DAMAGE (TYP.)


ANCHOR THROUGH NETTING

SECTION B-B

20" DIA. WATTI F

NOT TO SCALE

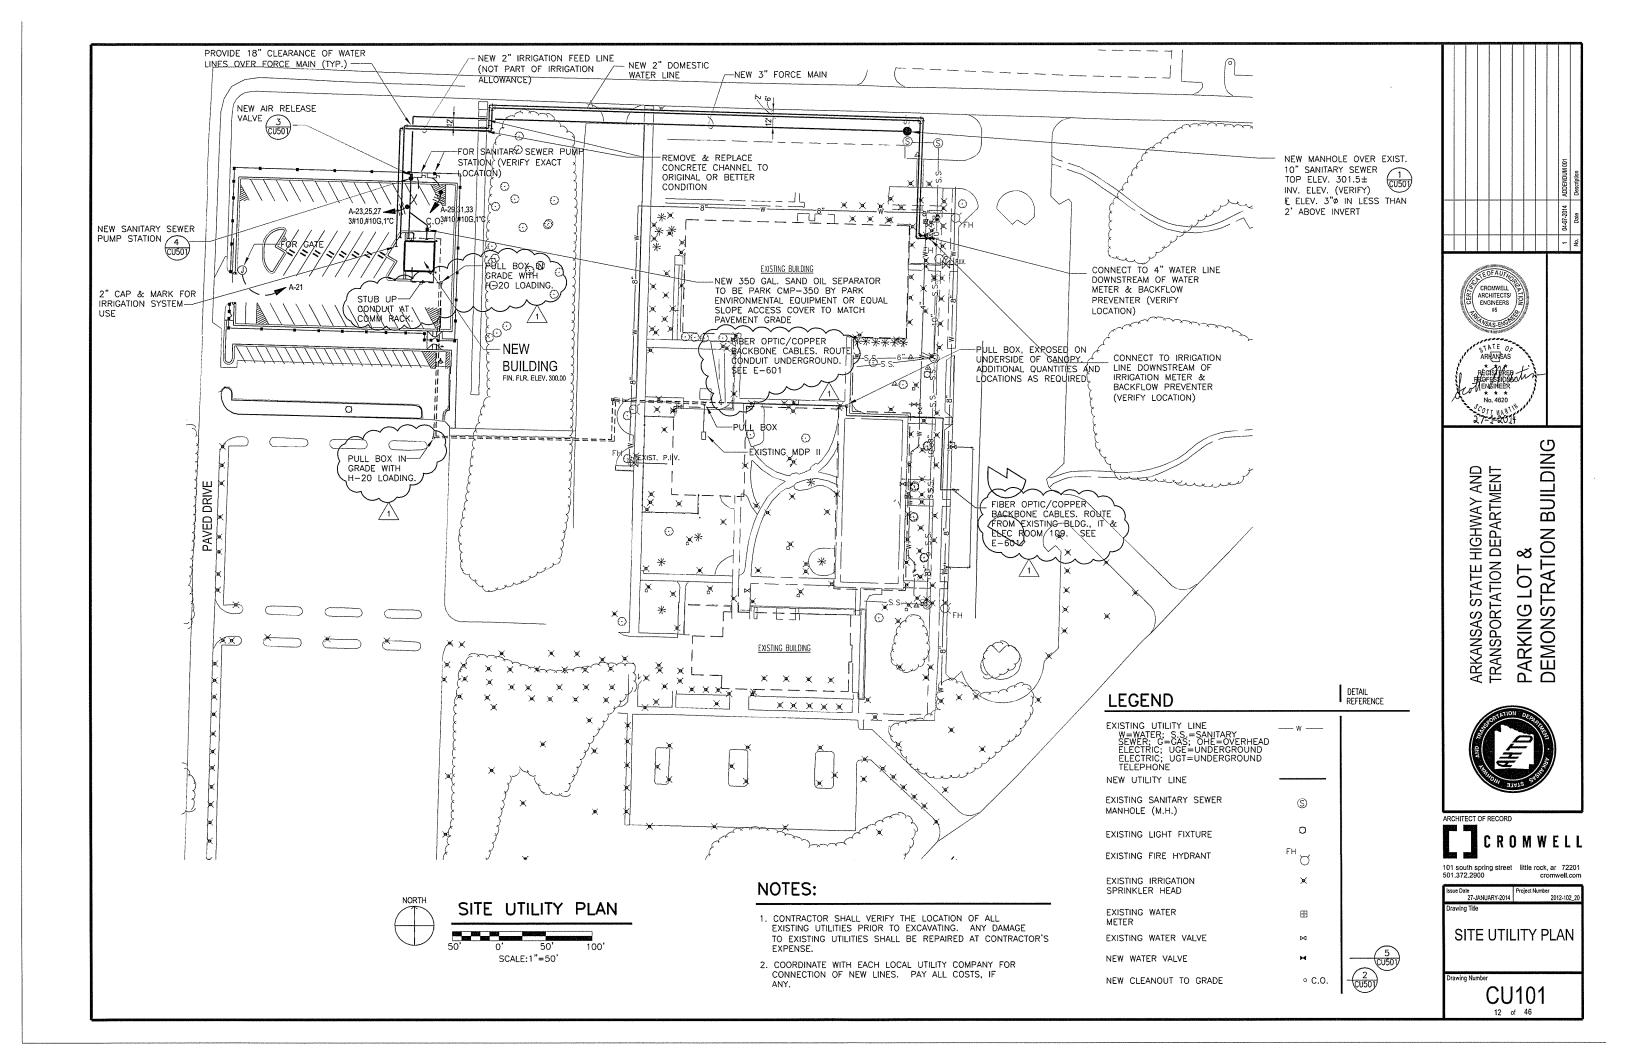

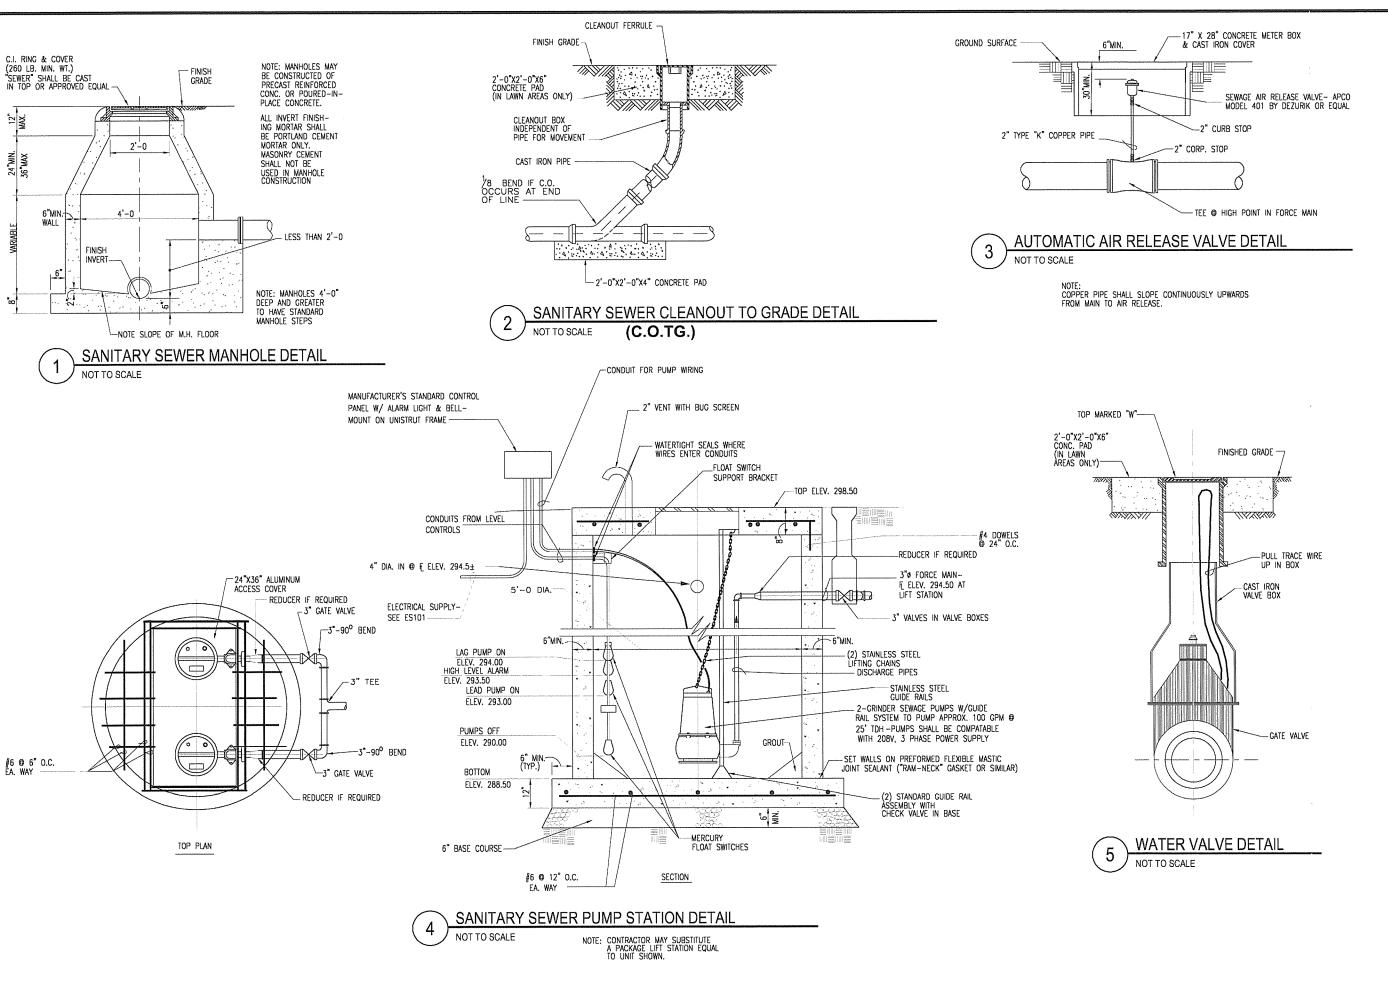

No Date Description



ARKANSAS STATE HIGHWAY AND TRANSPORTATION DEPARTMENT PARKING LOT & DEMONSTRATION BUILDING



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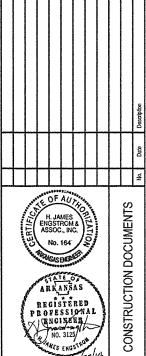
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Issue Date 27-JANUARY-2014 Project Number 2012-102 20

Orawing Number CU501

REQUIRED STRUCTURAL INSPECTIONS AND STATEMENT OF SPECIAL INSPECTIONS

		PER CHAP	PTER 17 OF CURRENT ARKANSAS FIRE PREVENTION CODE	VOLUME II BUILI	DING (BASED OF	N IBC CODE)		
ITEM	CONTINUOUS PERIODI	c	ITEM	CONTINUOUS	PERIODIC	ITEM	CONTINUOUS	PERIODIC
SOILS:			STEEL CONSTRUCTION:			MASONRY CONSTRUCTION:		1
I. VERIFY MATERIALS BELOW FOOTINGS AND SLAB AND UNDERCUT AREA EXTENDED BEYOND BUILDING PERIMETER ARE ADEQUATE TO ACHIEVE THE	, ×		MATERIAL VERIFICATION OF HIGH STRENGTH BOLTS, NUTS, AND WASHERS:			AS MASONRY CONSTRUCTION BEGINS, THE FOLLOWING SHALL BE VERIFIED TO ENSURE COMPLIANCE:		
DESIGN BEARING CAPACITY AND REQUIREMENTS OF GEOTECHNICAL ENGINEER.			A.IDENTIFICATION MARKINGS TO CONFORM TO ASTM STANDARDS SPECIFIED IN THE		^	A.THAT COMPRESSIVE STRENGTH OF CMU		×
			APPROVED CONSTRUCTION DOCUMENTS. B. MANUFACTURER'S CERTIFICATE OF		×	MASONRY WALL ASSEMBLAGE, I'm = 2000 psi B.PROPORTIONS OF SITE-PREPARED MORTAR		×
 VERIFY EXCAVATIONS ARE EXTENDED TO PROPER DEPTH AND HAVE REACHED PROPER MATERIAL. 	×		COMPLIANCE REQUIRED. 2. INSPECTION OF HIGH STRENGTH BOLTING:			AND GROUT C. PLACEMENT OF MASONRY UNITS AND CONSTRUCTION OF MORTAR JOINTS		×
3. PERFORM CLASSIFICATION AND TESTING OF CONTROLLED FILL MATERIALS.	×		A. BEARING TYPE CONNECTION.		×	D. LOCATION OF REINFORCEMENT, CONNECTORS, AND ANCHORAGES.		×
	×		3. INSPECTION OF WELDING: A. STRUCTURAL STEEL:			2. THE INSPECTION PROGRAM SHALL VERIFY:		
4. VERIFY USE OF PROPER MATERIALS, DENSITIES, AND LIFT THICKNESS DURING PLACEMENT AND COMPACTION OF CONTROLLED FILL.	^		I) COMPLETE AND PARTIAL PENETRATION GROOVE WELDS.	×		A. THAT COMPRESSIVE STRENGTH OF CMU MASONRY WALL ASSEMBLAGE, I'm = 2000 psi B.SIZE AND LOCATION OF STRUCTURAL		×
5. PRIOR TO PLACEMENT OF CONTROLLED FILL, OBSERVE SUBGRADE AND VERIFY THAT SITE HAS	×		2) MULTIPASS FILLET WELDS 3) SINGLE PASS FILLET WELDS GREATER THAN 5/16"	X		ELEMENTS. C.TYPE, SIZE AND LOCATION OF ANCHORS,		×
BEEN PREPARED PROPERLY			4) SINGLE PASS FILLET WELDS LESS THAN OR EQUAL TO 5/16"		×	INCLUDING OTHER DETAILS OF ANCHORAGE OF MASONRY TO STRUCTURAL MEMBERS,		×
CONCRETE CONSTRUCTION:			5) FLOOR AND ROOF DECK WELDS.		×	FRAMES OR OTHER CONSTRUCTION. D.SPECIFIED SIZE, GRADE, PLACEMENT AND		
I. INSPECTION OF REINFORCING STEEL AND	×		B. REINFORCING STEEL: 1) SHEAR REINFORCEMENT	×		TYPE OF REINFORGEMENT.		X
PLACEMENT. 2. INSPECT BOLTS TO BE INSTALLED IN CONCRETE	X		2) OTHER REINFORCING STEEL		X	E, PROTECTION OF MASONRY DURING COLD WEATHER (TEMPERATURE BELOW 40 F) OR HOT WEATHER (TEMPERATURES ABOVE 90 F)		×
AND/OR MASONRY WALLS PRIOR TO AND DURING PLACEMENT OF CONCRETE.	The same of the sa		4. STEEL JOISTS: A.MATERIAL VERIFICATION THAT JOISTS COMPLY WITH THAT SPECIFIED ON DRAWINGS		×	3. PRIOR TO GROUTING, THE FOLLOWING SHALL BE VERIFIED TO ENSURE COMPLIANCE:		
3. VERIFYING USE OF REQUIRED DESIGN MIX	×		AND SPECIFICATIONS. B.JOIST BRIDGING: YERIFY PLACEMENT AND			A. GROUT SPACE IS CLEAN.		×
4. AT THE TIME FRESH CONCRETE IS SAMPLED TO			LOCATIONS.		×	B. PLACEMENT OF REINFORCEMENT AND CONNECTORS AND ANCHORAGES.		×
FABRICATE SPECIMENS FOR STRENGTH TESTS,	X		C.ANCHORAGE WELDING TO SUPPORTS D.INSTALLATION	-	×	C. PROPORTIONS OF SITE-PREPARED GROUT. D. CONSTRUCTION OF MORTAR JOINTS.		X
PERFORM SLUMP AND AIR CONTENT TESTS, AND DETERMINE THE TEMPERATURE OF THE CONCRETE.			MECHANICAL & ELECTRICAL COMPONENTS:			4. GROUT PLACEMENT SHALL BE VERIFIED TO ENSURE COMPLIANCE WITH CODE AND	×	
5. INSPECTION OF CONCRETE PLACEMENT FOR PROPER APPLICATION TECHNIQUES.	×		SEE MECHANICAL AND ELECTRICAL DRAWINGS AND SPECIFICATIONS FOR REQUIRED ANCHORAGE SYSTEMS AND SEISMIC SYSTEMS.			CONSTRUCTION DOCUMENT PROVISIONS. 5. PREPARATION OF ANY REQUIRED GROUT SPECIMENS, MORTAR SPECIMENS AND/OR PRISMS	×	
6. INSPECTION FOR MAINTENANCE OF SPECIFIED CURING TEMPERATURES AND TECHNIQUES.	×		I. ANCHORAGE OF ELECTRICAL EQUIPMENT FOR EMERGENCY OR STANDBY POWER SYSTEMS IN		×	SHALL BE OBSERVED. 6. COMPLIANCE WITH REQUIRED INSPECTION PROVISIONS OF THE CONSTRUCTION DOCUMENTS		
7. VERIFICATION OF IN-SITU CONCRETE STRENGTH, PRIOR TO REMOVAL OF SHORES AND FORMS FROM BEAMS AND STRUCTURAL SLABS.	×		2. INSTALLATION OF PIPING SYSTEMS INTENDED TO CARRY FLAMMABLE, COMBUSTIBLE OR HIGHLY		×	AND THE APPROVED SUBMITTALS SHALL BE VERIFIED.		×
8. INSPECT FORMWORK FOR SHAPE, LOCATION, AND DIMENSIONS OF THE CONCRETE MEMBER BEING FORMED.	×		TOXIC CONTENTS AND THEIR ASSOCIATED MECHANICAL UNITS AND HVAC DUCTWORK CONTAINING HAZARDOUS MATERIALS AND ANCHORAGE OF SUCH TO DUCTWORK.					
9. INSPECT VAPOR BARRIER/RETARDER FOR USE OF SPECIFIED MATERIAL AND PROPER PLACEMENT.	×		3, EXAMINE SEISMIC SYSTEM DESIGNED BY THE RESPONSIBLE MECHANICAL AND ELECTRICAL PROFESSIONAL ENGINEERS IN CHARGE REQUIRING					to approximate and approximate
			SEISMIC QUALIFICATION IN ACCORDANCE WITH ARKANSAS FIRE PREVENTION CODE (IBC) SECTION 1708-5AND VERIFY THE LABEL, ANCHORAGE OR MOUNTING CONFORMS TO THE CERTIFICATE OF COMPLIANCE.			NOTES: SEE DRAWING 5-002 FOR NOTES		e de la constanta de la consta
						APPLICABLE TO THE REQUIRED STRUCTURAL INSPECTIONS AND STATEMENT OF SPECIAL INSPECTIONS.		



REGISTERED PROFESSIONAL (RNGINERAL) NO. 3125

ARKANSAS STATE HIGHWAY AND
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PARKING LOT &
DEMONSTRATION BUILDING



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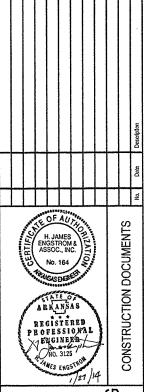
Project Number 1/27/14 2012-102_20

Drawing Title

STRUCTURAL **QUALITY CONTROL**

Drawing Number

REQUIRED STRUCTURAL INSPECTIONS AND STATEMENT OF SPECIAL INSPECTIONS - (CONTINUATION OF DRAWING S-001) PER CHAPTER IT OF CURRENT ARKANSAS FIRE PREVENTION CODE VOLUME II BUILDING (BASED ON IBC CODE) (SEE DRAWING 5-001) I. CONTRACTOR IS TO BE RESPONSIBLE FOR SUBMITTING THE WRITTEN STATEMENT OF RESPONSIBILITY REQUIRED BY THE CURRENT ARKANGAS FIRE PREVENTION CODE VOLUME II BUILDING (IBC) (HEREINAFTER REFERRED TO AS THE BUILDING CODE)SECTION 1706.1 REGARDING CONSTRUCTION OF THE MAIN SEISMIC-FORCE-RESISTING SYSTEM AND CONTAINING THE FOUR ITEMS LISTED THEREIN. 2. THE ITEMS CHECKED WITH AN "X" SHALL BE INSPECTED IN ACCORDANCE WITH THE CURRENT BUILDING CODE CHAPTER 17 BY AN INSPECTOR FROM AN ESTABLISHED AND CERTIFIED TESTING AGENCY. THE TESTING AGENCY SHALL SEND COPIES OF ALL STRUCTURAL TESTING AND INSPECTION REPORTS DIRECTLY TO THE ARCHITECT, ENGINEER, CONTRACTOR, OWNER AND BUILDING OFFICIAL. ANY MATERIALS WHICH FAIL TO MEET THE PROJECT SPECIFICATIONS SHALL IMMEDIATELY BE BROUGHT TO THE ATTENTION OF THE ARCHITECT, ENGINEER, AND OWNER. SPECIAL INSPECTION TESTING REQUIREMENTS APPLY EQUALLY TO ALL BIDDER DESIGNED COMPONENTS. 3. CONTINUOUS SPECIAL INSPECTION MEANS THAT THE INSPECTOR IS ON SITE AT ALL TIMES OBSERVING THE WORK REQUIRING SPECIAL INSPECTION, PERIODIC SPECIAL INSPECTION MEANS THAT THE SPECIAL INSPECTOR IS ON SITE AT TIME INTERVALS NECESSARY TO CONFIRM THAT ALL WORK REQUIRING SPECIAL INSPECTION IS IN COMPLIANCE. 4. ALL WELDS SHALL BE VISUALLY INSPECTED AT A MINIMUM, IN ADDITION TO ANY OTHER REQUIREMENTS IN THESE 5. ALL COMPLETE PENETRATION WELDS SHALL BE TESTED ULTRASONICALLY BY USE OF A COMPARABLE APPROVED 6. STRUCTURAL INSPECTIONS SHALL CONFORM TO THE REQUIREMENTS OF THE CURRENT BUILDING CODE, CHAPTER



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Issue Date

1/27/14 Project Number 2012-102_20

STRUCTURAL QUALITY CONTROL

Drawing Number

BUILDING DESIGN CRITERIA.

ROOF LIVE LOAD: 20 psf GROUND SNOW LOAD: 10 psf

WIND EXPOSURE = B

FIGURE 6-3

WIND LOADING ON WALL

CORNERS: ZONE 5 OF FIGURE

OTHER WALL AREAS: ZONE 4 OF

EARTHQUAKE DATA 1 = 1.0

WIND LOADING: BASIC WIND SPEED = 90 mph IMPORTANCE FACTOR, I = 1.0 METHOD I - SIMPLIFIED PROCEDURE COMPONENTS AND CLADDING: PER ASCE 7 METHOD I, FIGURE 6.3 WITHIN "a" DISTANCE OF

Sa = 0.5 Si = 0.17 OCCUPANCY CATAGORY = II SITE CLASS = C Sos = 0.4

SEISMIC DESIGN CATAGORY = SDC = C 5m = 0

BASIC SEISMIC FORCE RESISTING SYSTEM = REINFORCED MASONRY SHEAR WALLS DESIGN BASE SHEAR = 21.35 kips

F505/R = 0.114

R = 35

ANALYSIS PROCEDURE = SIMPLIFIED ALTERNATIVE STRUCTURAL DESIGN PROCEDURE

GENERAL NOTES

- (1) STRUCTURAL DESIGN OF BUILDING IS FOR THE COMPLETED STRUCTURE. CONTRACTOR IS TO BE RESPONSIBLE FOR MAINTAINING A SAFE AND STRUCTURAL SOUND STRUCTURE DURING IT'S CONSTRUCTION UNTIL IT IS COMPLETED, CONTRACTOR SHALL BE RESPONSIBLE FOR DESIGNING AND FURNISHING ALL NECESSARY TEMPORARY BRACING, SHORING, GUYS, CABLES AND ANY OTHER MEANS NECESSARY TO DO THIS AND TO INSURE THAT THE ERECTED STRUCTURES ARE PROPERLY PLUMBED, LEVELED, AND ALIGNED.
- (2) PERMANENT STABILITY OF THE BUILDING AND COMPONENTS IS NOT PROVIDED UNTIL ALL THE STRUCTURAL ELEMENTS ARE INSTALLED AS SHOWN ON THE CONTRACT DRAWINGS; THE CONTRACTOR IS RESPONSIBLE FOR PROVIDING STABILITY TO ALL NON-SELF SUPPORTING ELEMENTS AND SAFETY TO ALL WORKERS, ANIMALS AND PROPERTY DURING CONSTRUCTION AND UNTIL ALL STRUCTURAL ELEMENTS ARE INSTALLED.
- (3) BRACING USED TO STABILIZE THE BUILDING DURING THE ERECTION PROCESS SHALL BE DESIGNED BY THE CONTRACTOR SO AS NOT TO TWIST OR DISTORT MEMBERS.
- (4) STRUCTURAL DRAWINGS SHALL BE USED IN CONJUNCTION WITH DRAWINGS RELATING TO OTHER TRADES. GENERAL CONTRACTOR SHALL BE RESPONSIBLE FOR CHECKING AND COORDINATING DIMENSIONS, CLEARANCES OPENINGS, PIPE SLEEVES, CURBS, ETC. WITH THE WORK OF OTHER TRADES.
- (5) PRINCIPAL OPENINGS THROUGH THE FRAMING MAY BE SHOWN ON THESE DRAWINGS. THE GENERAL CONTRACTOR SHALL EXAMINE THE DRAWINGS FOR REQUIRED OPENINGS AND SHALL PROVIDE FOR ALL OPENINGS WHETHER SHOWN ON THESE DRAWINGS OR NOT, AND SHALL VERIFY SIZE AND LOCATION OF ALL OPENINGS WITH ALL SUB-CONTRACTORS. NOMINAL PIPE SLEEVES THROUGH THE DECK WILL NOT REQUIRE FRAMING UNLESS THE OPENING EXCEEDS 6" IN DIAMETER. IF THIS OCCURS, NOTIFY STRUCTURAL ENGINEER AND OBTAIN HIS WRITTEN INSTRUCTIONS BEFORE BEGINNING WORK.
- (6) ALL DIMENSIONS SHALL TAKE PRECEDENCE OVER SCALE SHOWN ON PLANS, SECTIONS, AND DETAILS.
- (7) THE CONTRACTOR SHALL INSURE THAT ALL CONSTRUCTION LOADS DO NOT EXCEED THE DESIGN LIVE LOADS INDICATED ON THE STRUCTURAL DRAWINGS AND THAT THESE LOADS ARE NOT PUT ON THE STRUCTURAL MEMBERS PRIOR TO THE TIME THAT THE CONCRETE REACHES THE FULL DESIGN STRENGTH AND ALL FRAMING MEMBERS AND THEIR CONNECTIONS ARE IN PLACE.
- (8) FOUNDATION DESIGN IS BASED ON SOIL INVESTIGATION AND REPORT BY THE GEOTECHNICAL ENGINEER, GRUBBS, HOSKINS, BARTON, & MYATT, #I TRIGON PLACE, LITTLE ROCK, AR. 72209; PHONE 501-455-2536 CONTRACTOR IS TO OBTAIN A COPY OF SUCH AND BECOME FAMILIAR WITH ALL IT'S REQUIREMENTS PRIOR TO SUBMITTING HIS BID FOR THE WORK.
- (9) CONTRACTOR TO PROVIDE FOR DRAINAGE OF EXCAVATIONS FROM SURFACE WATER, GROUND WATER, AND SEEPAGE. FOOTING EXCAVATIONS SHALL BE DRAINED OR PUMPED DRY, RECOMPACTED, AND REINSPECTED BEFORE POURING CONCRETE.
- (A) ALLOWABLE PRESSURE OF 1500 PSF USED FOR THE DESIGN OF CONTINUOUS FOOTINGS IS BASED UPON THEM BEING FOUNDED AT A MINIMUM DEPTH SHOWN ON DRAWINGS AND THAT CONTRACTOR SHALL HAVE GEOTECHNICAL ENGINEER INSPECT FOOTING EXCAVATIONS AND APPROVE SUCH BEFORE BEGINNING CONSTRUCTION OF CONCRETE FOOTING. SEE SOIL REPORT
- (II) ALL CONCRETE WORK IS TO BE IN ACCORDANCE WITH THE AMERICAN CONCRETE INSTITUTE'S SPECIFICATIONS FOR STRUCTURAL CONCRETE FOR BUILDINGS, ACI 301" LATEST EDITION.
- (2) ALL CONCRETE IS TO HAVE A MINIMUM STRENGTH F'C = 4000 PBI AT 28 DAYS VERIFIED BY CYLINDER TESTS AT THE CONTRACTOR'S EXPENSE.
- (3) REINFORCING STEEL SHALL COMPLY WITH ASTM A-615 GRADE 60 (MIN. YIELD STRENGTH 60,000 psi).
- (4) ALL REINFORCING SHALL BE SECURELY HELD IN PLACE WHILE PLACING CONCRETE. IF REQUIRED, ADDITIONAL BARS AND STIRRUPS SHALL BE PROVIDED BY THE CONTRACTOR TO FURNISH SUPPORT FOR
- (5) ALL REINFORCING SHALL BE LAPPED AS SHOWN ON DRAWINGS.
- (6) PROVIDE CORNER BARS IN ALL CONCRETE MEMBERS AT INTERSECTIONS. MATCH SIZE AND SPACING OF HORIZONTAL BARS IN THOSE MEMBERS.
- (7) REINFORCING BARS SHALL NOT BE WELDED.
- (B) COARSE AGGREGATE FOR CONCRETE SHALL NOT CONTAIN LIGNITE, STEEL OR OTHER MATERIALS THAT MAY BE DETRIMENTAL TO THE CONCRETE.
- (9) ALL STRUCTURAL STEEL WORK IS TO BE PER THE BEST PRACTICE OF THE "MANUAL OF STEEL CONSTRUCTION, LATEST EDITION". AMERICAN INSTITUTE OF STEEL CONSTRUCTION (AISC).
- (20) STRUCTURAL STEEL W-SHAPED MEMBERS: ASTM A992, Fy = 50 ksl MISC. PLATES, ANGLES, AND BARS: a. WHEN CONNECTED TO W SHAPED OR OTHER ASTM A992 MATERIAL, MISC. TO BE : ASTM A992, Fy = 50 ksi b. OTHERWISE, ASTM A36
 - ALL MEMBERS TO BE FULL LENGTH WITHOUT ANY SPLICES UNLESS SHOWN OTHERWISE ON THESE DRAWINGS.
- (2) ALL WELDING IS TO BE IN ACCORDANCE WITH THE AMERICAN WELDING SOCIETY (AWS) SPECIFICATIONS USING ETOXX ELECTRODES AND SHALL BE DONE BY CERTIFIED WELDERS.
- (22) METAL ROOF DECK IS TO BE TYPE 1.5F 20 ga.
- HORIZONTAL REINFORCING IN EVERY HORIZONTAL JOINT (AND CONNECTION TO FACE BRICK REINFORCEMENT). HOHMANN & BARNARD, INC. (HB) #270 LADDER EYE WIRE WITH SEISMIC HOOK FOR SINGLE MYTHE CMU WALL WITH SUPER DUTY (SHD)WIRE SIZE (DOUBLE 3/16" SIDE RODS × 3/16" CROSS RODS) FOR 7 5/6" CONCRETE MASONRY WALL (6" NOMINAL), HOT DIPPED GALVANIZED ASTM A 153 (1.5 OZ./FT.). IN ALL FACE BRICK JOINTS, USE HB LADDER EYE-WIRE SUPER HEAVY DUTY, HOT DIP GALVANIZED AND CONNECTED TO CMU WALL HORIZONTAL JOINT REINFORCEMENT. NO SUBSTITUTIONS, USE MANUFACTURERS SPECIAL CORNER PIECES AT EACH BUILDING CORNER, LAP SPLICE LENGTH SHALL BE 1'-O" AND SHALL OCCUR AT SPECIAL CORNER PIECES
- (24) MINIMUM COMPRESSIVE STRENGTH OF CMU MASONRY WALL ASSEMBLAGE (CMU + GROUT), Fin = 2000 psi






ARKANSAS REGISTERED PROFESSIONAL ENGINEER) NO. 3125 HES FHG

CONSTRUCTION

BUILDING : HIGHWAY AND I DEPARTMENT LOT & FRATION ARKANSAS STATE H TRANSPORTATION D S RKING MOM



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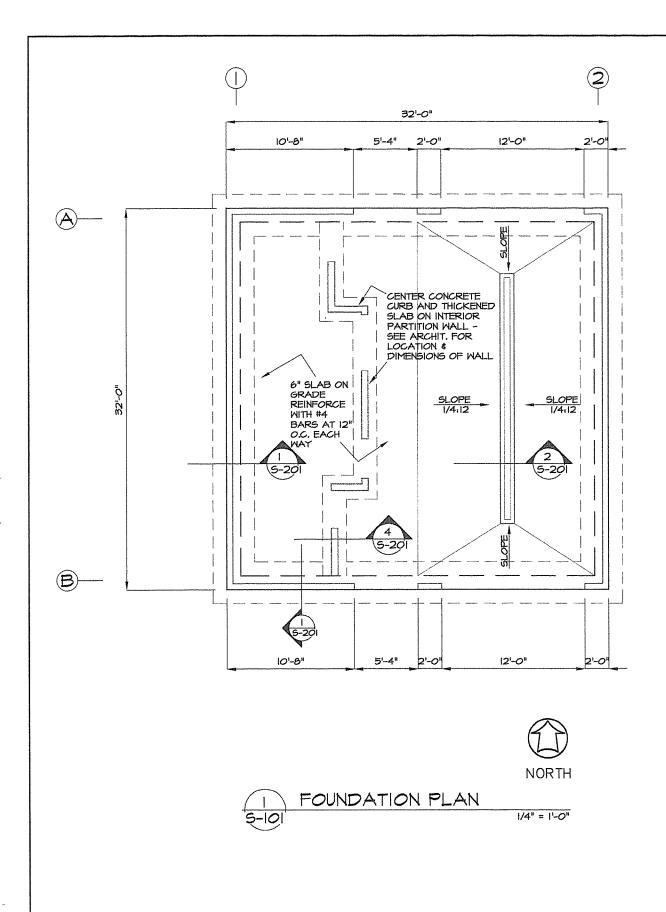


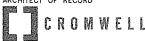
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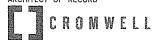
GENERAL NOTES

Drawing Numbe





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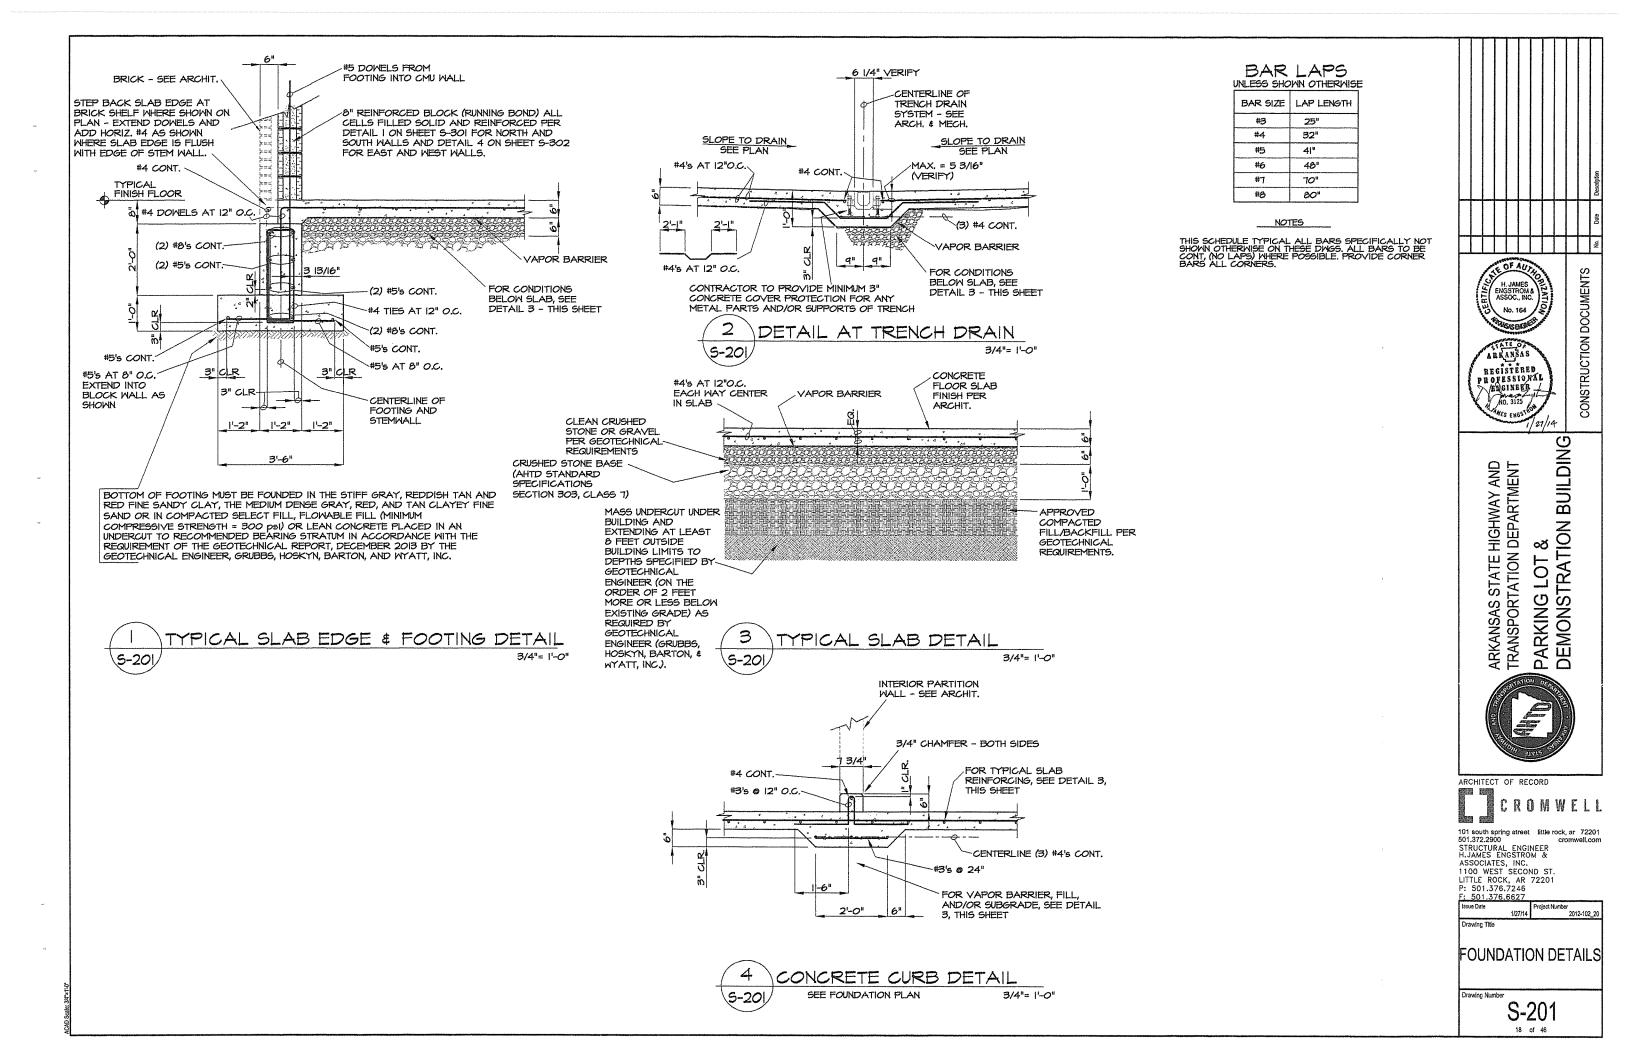
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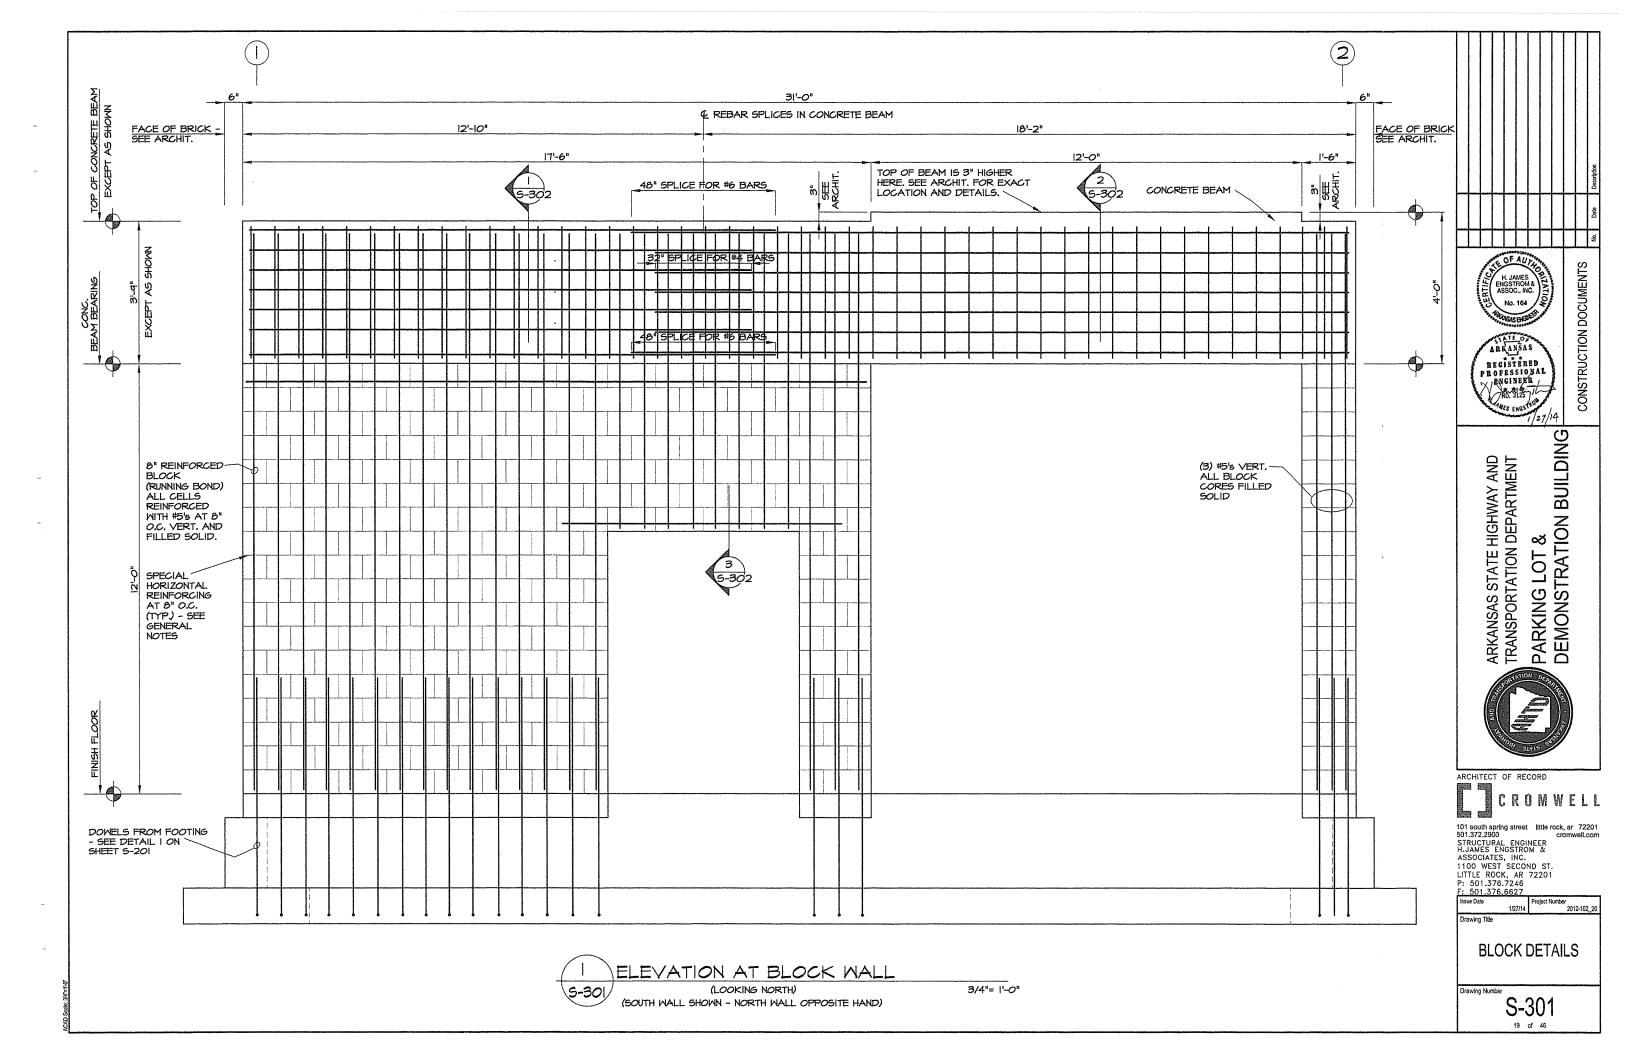
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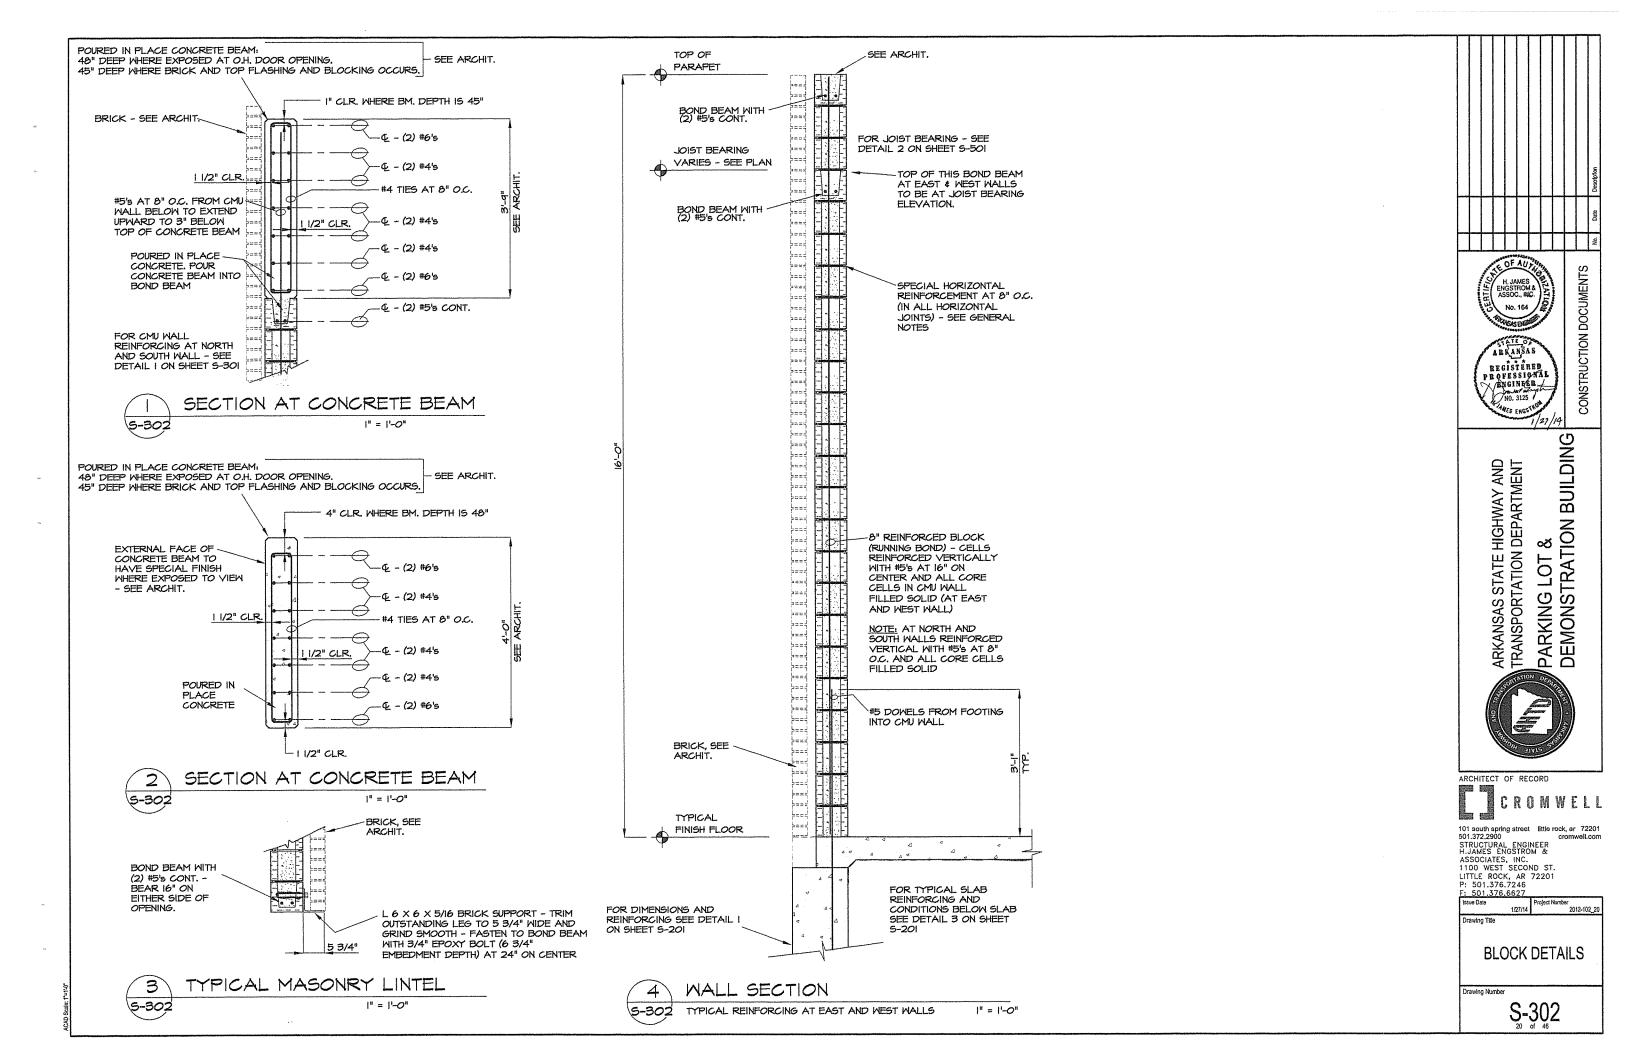
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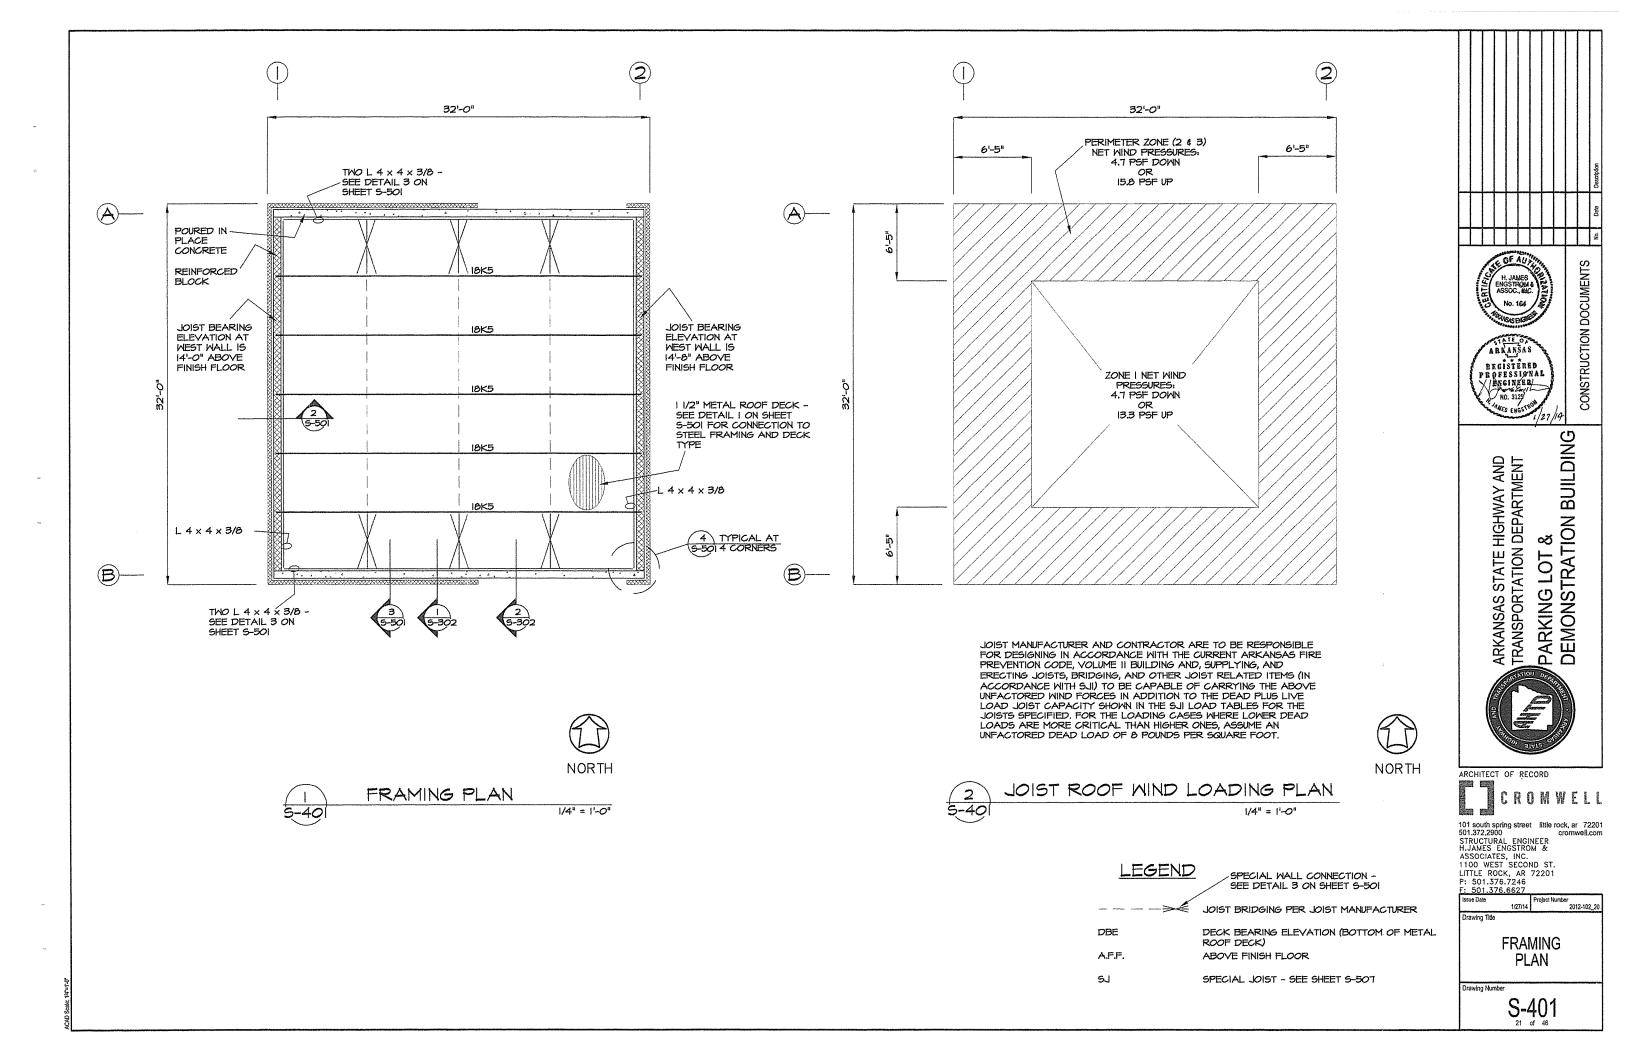
FOUNDATION

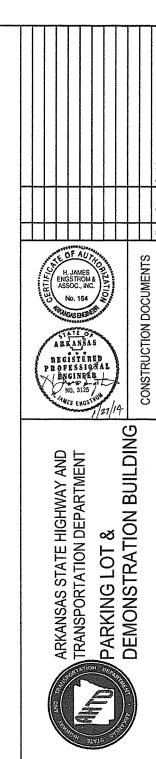
PLANS









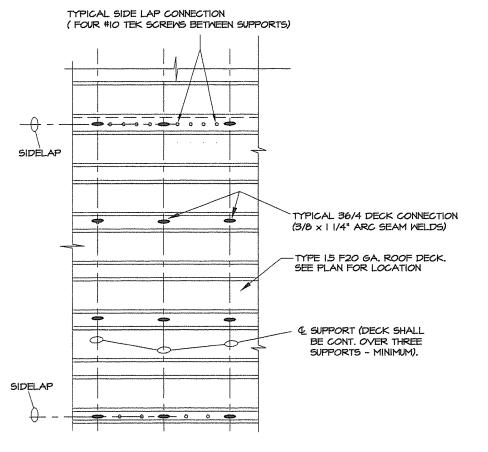


TYPICAL DECK CONNECTION PATTERN PLAN = 36/4 (WELDS @ 12"O.C. @ SUPPORTS)

NOTE: METAL ROOF DECK IS TO BE CONNECTED WITH A 36/4 PATTERN USING $3/6 \times 11/4$ " ARC SEAM WELDS. ALL SIDE LAPS ARE TO BE CONNECTED WITH FOUR #10 TEK SCREW EQUALLY SPACED BETWEEN SUPPORTS. ALL SIDE SUPPORTS ARE TO BE CONNECTED MITH 3/6 x I 1/4" ARC SEAM WELDS AT 12" ON CENTER, TYP., UNLESS NOTED OTHERWISE IN DRAWINGS.


TYPICAL ROOF DECK & ANCHORAGE DETAILS

N.T.S.

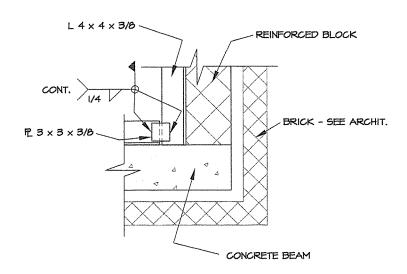


PLAN VIEW

CONNECTION DETAIL 1 1/2" = 1'-0" 5-50

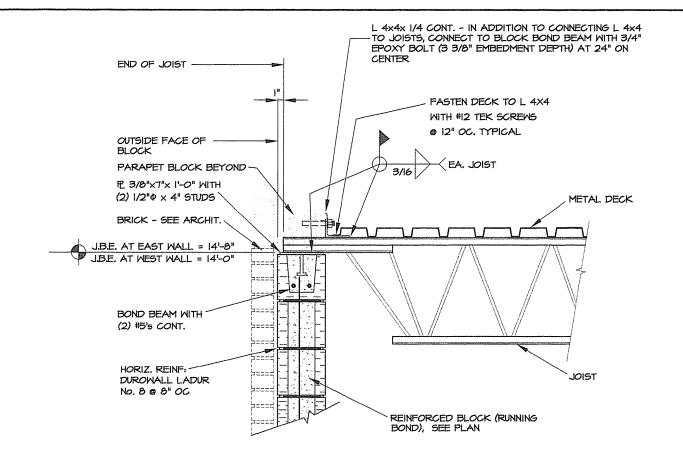

JOIST BEARING DETAIL 1 1/2" = 1'-0"

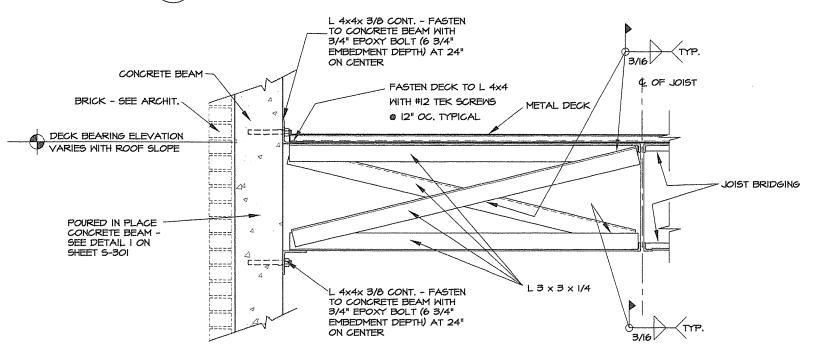

DECK BEARING DETAIL & MALL CONNECTION 5-50

1 1/2" = 1'-0"

CONSTRUCTION DOCUMENTS ABRANSA REGISTERED PROFESSIONAL ENGINEER (NO. 3125 PARKING LOT & DEMONSTRATION BUILDING ARKANSAS STATE HIGHWAY AND TRANSPORTATION DEPARTMENT



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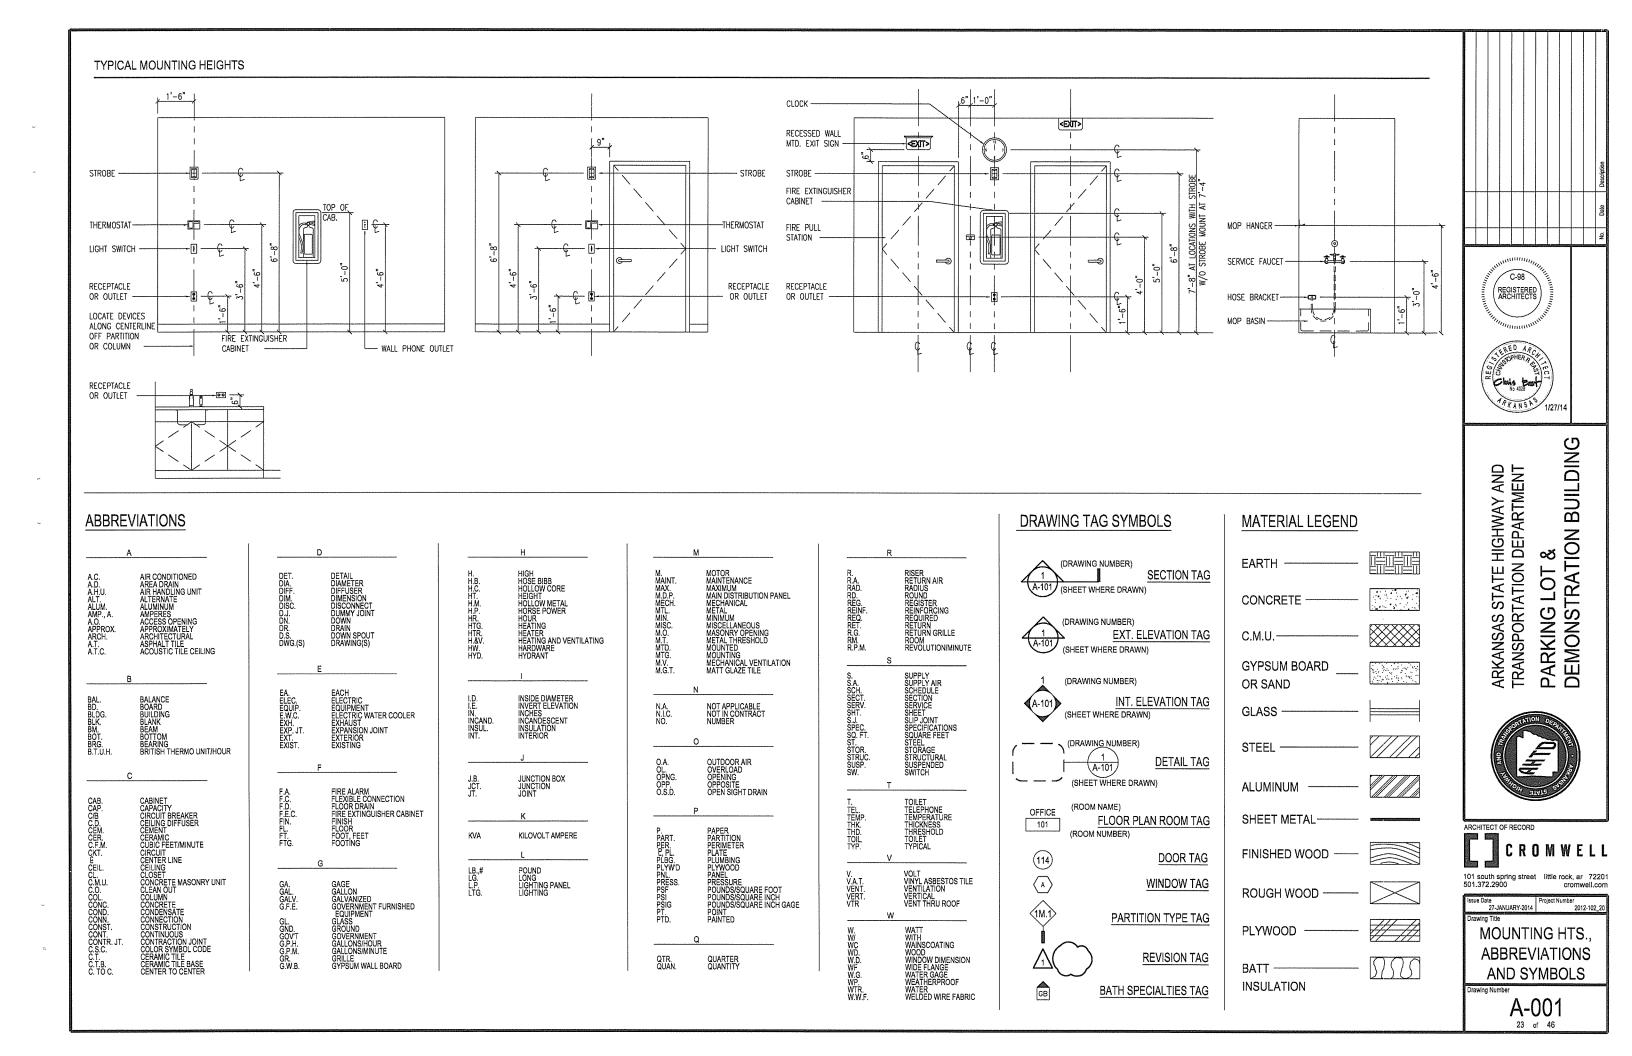
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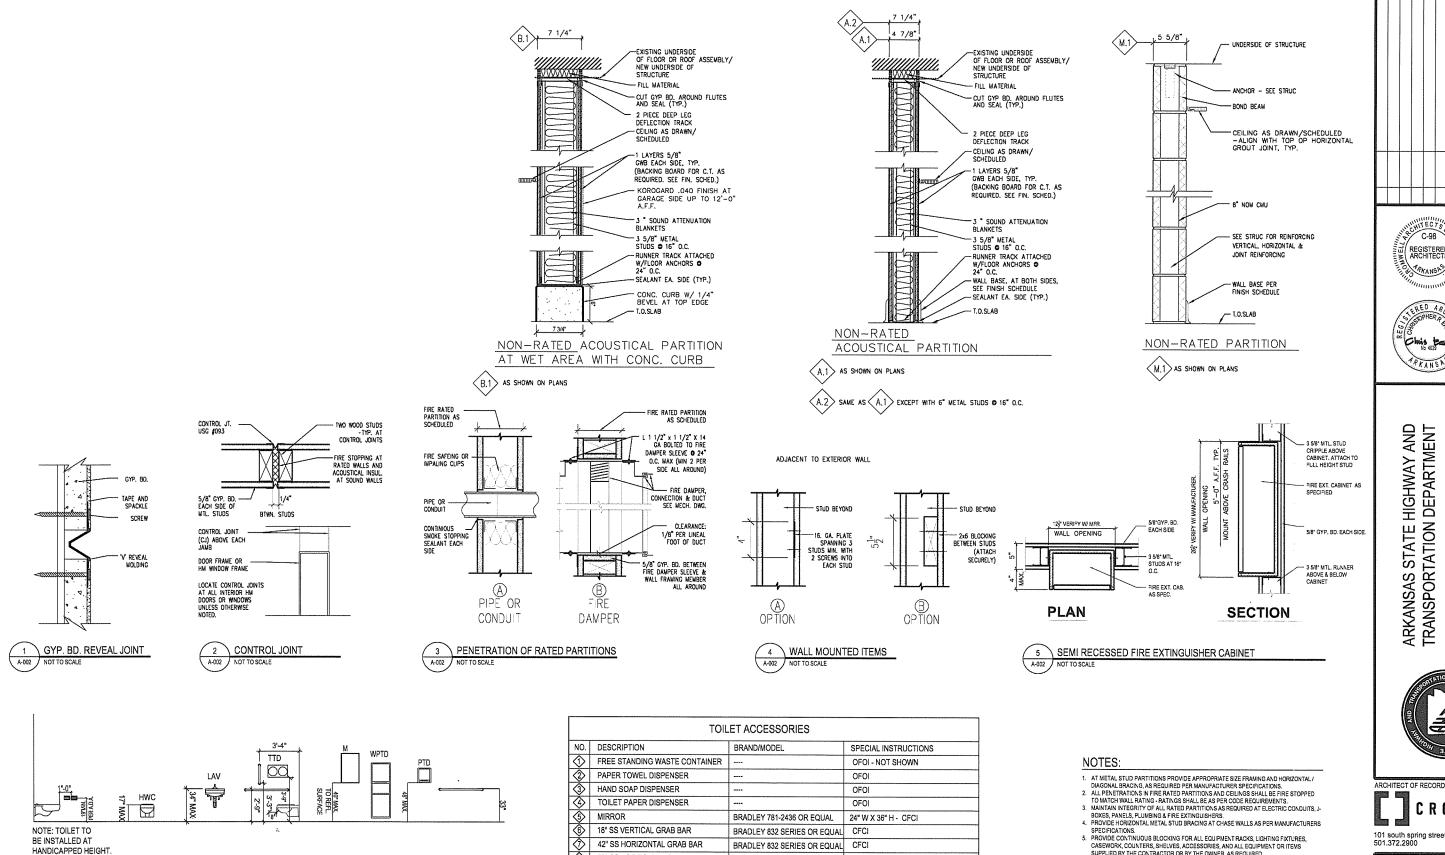
FRAMING DETAILS

Drawing Number

S-501

5-501





36" SS HORIZONTAL GRAB BAR

STANDARD MOUNTING HEIGHTS

A-002

- PROVIDE CONTINUOUS ELCCAINS FOR ALL EQUIPMENT RACKS, LIGHTING FIXTURES,
 CASEWORK, COUNTERS, SHELVES, ACCESSORIES, AND ALL EQUIPMENT OR ITEMS
 SUPPLIED BY THE CONTRACTOR OR BY THE OWNER, AS REQUIRED.
 REFER TO FINISH SCHEDULE FOR PRINSHES ARE NOT SHOWN ON WALL TYPES).
 ALL DIMENSIONS ARE TO THE FACE OF PARTITION UNLESS OTHERWISE SHOWN.
 ANY DISCREPANCES IN DIMENSIONS SHALL BE BROUGHT TO THE ATTENTION OF THE
 ARCHITECT PRIOR TO CONSTRUCTION.

TOILET ACCESSORY SCHEDULE A-002 NO SCALE

BRADLEY 832 SERIES OR EQUAL CFCI

ACCESSORIES - SEE 4/A-302.

OFOI - OWNER FURNISHED, OWNER INSTALLED CFCI - CONTRACTOR FURNISHED, CONTRACTOR INSTALLED

INSTALLED TO MEET ADA REQUIREMENTS.

ALL OWNER OR CONTRACTOR INSTALLED ITEMS TO BE

PROVIDE 6" TREATED WOOD BLOCKING BEHIND ALL

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C-98

ARKANSAS STATE HIGHWAY AND TRANSPORTATION DEPARTMENT

ARKANSAS

REGISTERED ARCHITECTS


PHANSAS

DEMONSTRATION BUILDING


PARKING LOT


PARTITION SCHEDULE

A = 002

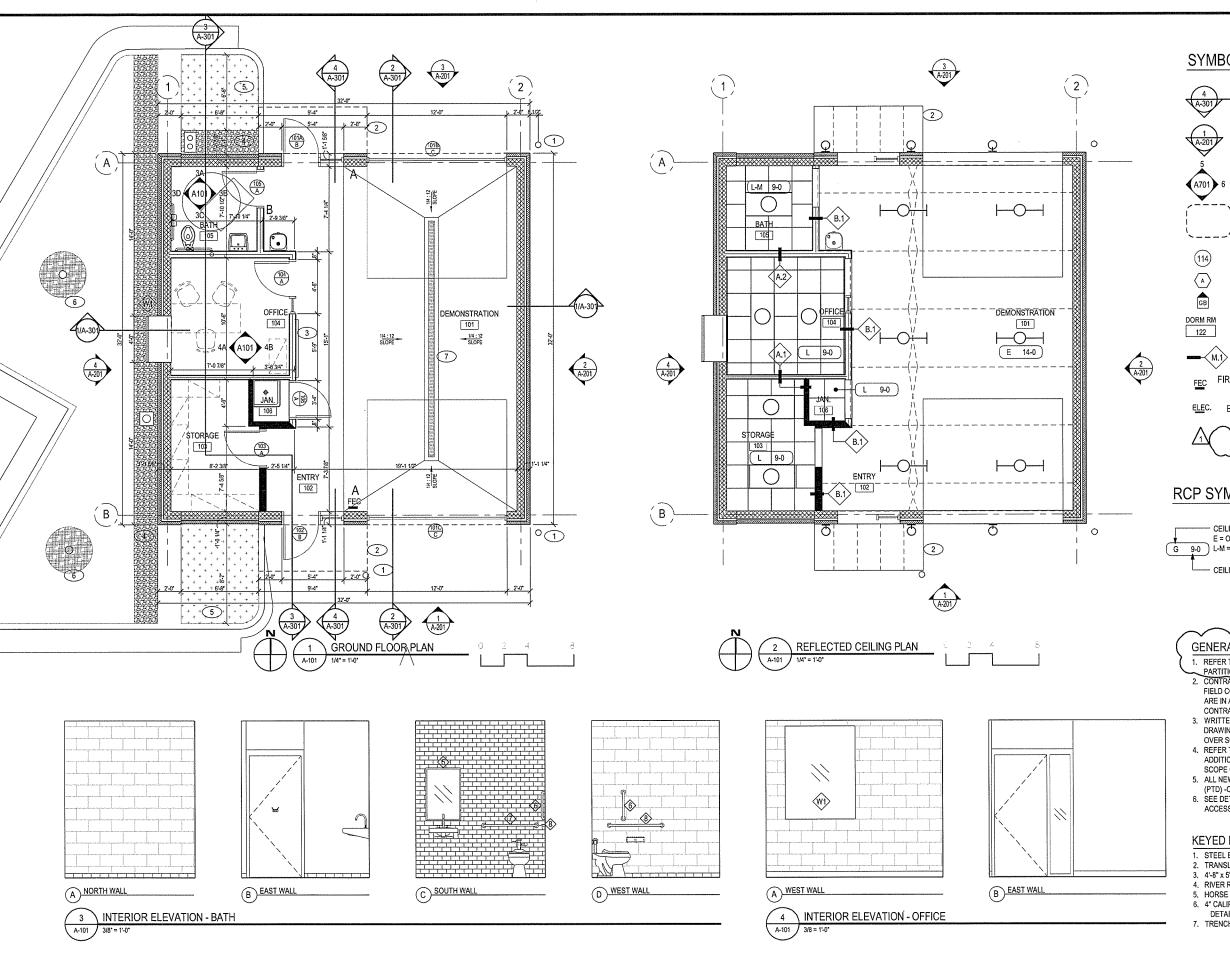


SYMBOL LEGEND

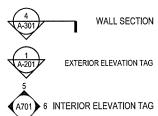

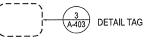



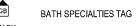

PARTITION TYPE TAG

FLR PLAN ROOM TAG

FIRE EXTINGUISHER CABINET SEE DETAIL 5/A002

ELECTRICAL PANEL BOARD



REVISION TAG

RCP SYMBOL LEGEND

CEILING TYPE: G = GYPSUM BOARD E = OPEN TO STRUCTURE, L = LAY-IN,
G 9-0 L-M = LAY-IN MOISTURE RESISTANT

- CEILING HEIGHT

GENERAL NOTES:

1. REFER TO SHEET A-002 FOR INTERIOR PARTITION TYPES.
2. CONTRACTOR SHALL VERIFY THAT ALL

- FIELD CONDITIONS AND DIMENSIONS ARE IN ACCORDANCE WITH THE CONTRACT DOCUMENTS.

 3. WRITTEN DIMENSIONS ON THESE
- DRAWINGS SHALL HAVE PRECEDENCE OVER SCALED DIMENSIONS.
- 4. REFER TO M.E.P. DRAWINGS FOR ADDITIONAL INFORMATION & FULL SCOPE OF M.E.P. WORK
- 5. ALL NEW GWB WALLS TO BE PAINTED (PTD) -ORANGE PEEL.
- 6. SEE DETAILS 6&7 A002 FOR TOILET ACCESSORY SCHEDULE.

KEYED NOTES:

- STEEL BOLLARD. SEE DETAIL 6/A402
 TRANSLUCENT AWNING ABOVE
- 3. 4'-8" x 5'-0" CORK TACKBOARD
- RIVER ROCK BASE, SEE DETAIL 4/A502
- HORSE TRAIL REED PLANTING 6. 4" CALIPER GINKO BILOBA TREE, SEE
- DETAIL 7/A402 TRENCH DRAIN




BUILDING ARKANSAS STATE HIGHWAY AND TRANSPORTATION DEPARTMENT PARKING LOT & DEMONSTRATION



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FLOOR	PLANS
& INT	ERIOR
ELEVA	TIONS



GENERAL NOTES:

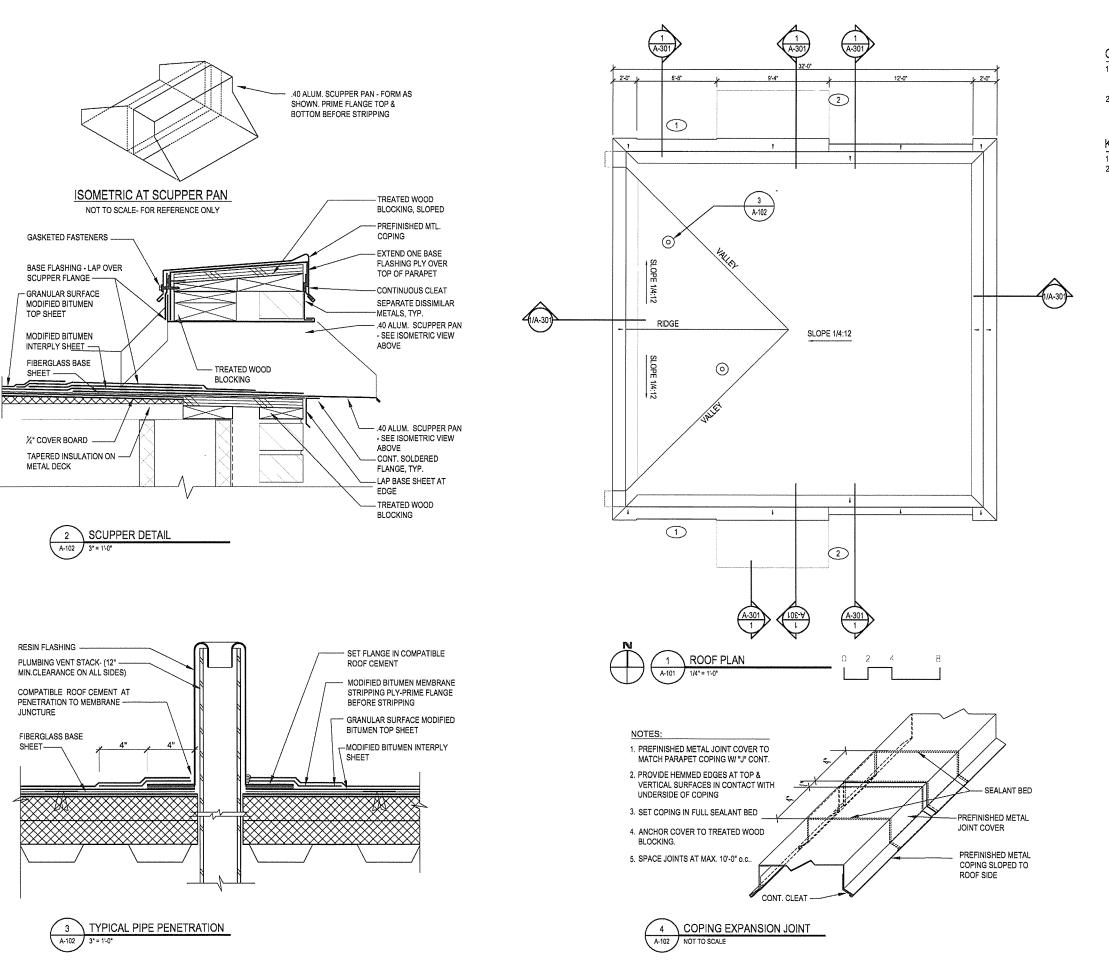- ALL ROOF SLOPE TO BE CREATED WITH SLOPED STRUCTURE, UNLESS OTHERWISE NOTED.
- 2. ALL DOWNSPOUTS TO BE 6" ROUND PREFINISHED METAL TO MATCH COLOR ACM-2.

KEYED NOTES:

- SCUPPER 6'-8" WIDE x 6" TALL
 TRANSLUCENT AWNING BELOW SEE ELEVATIONS.





BUILDING ARKANSAS STATE HIGHWAY AND TRANSPORTATION DEPARTMENT PARKING LOT & DEMONSTRATION B





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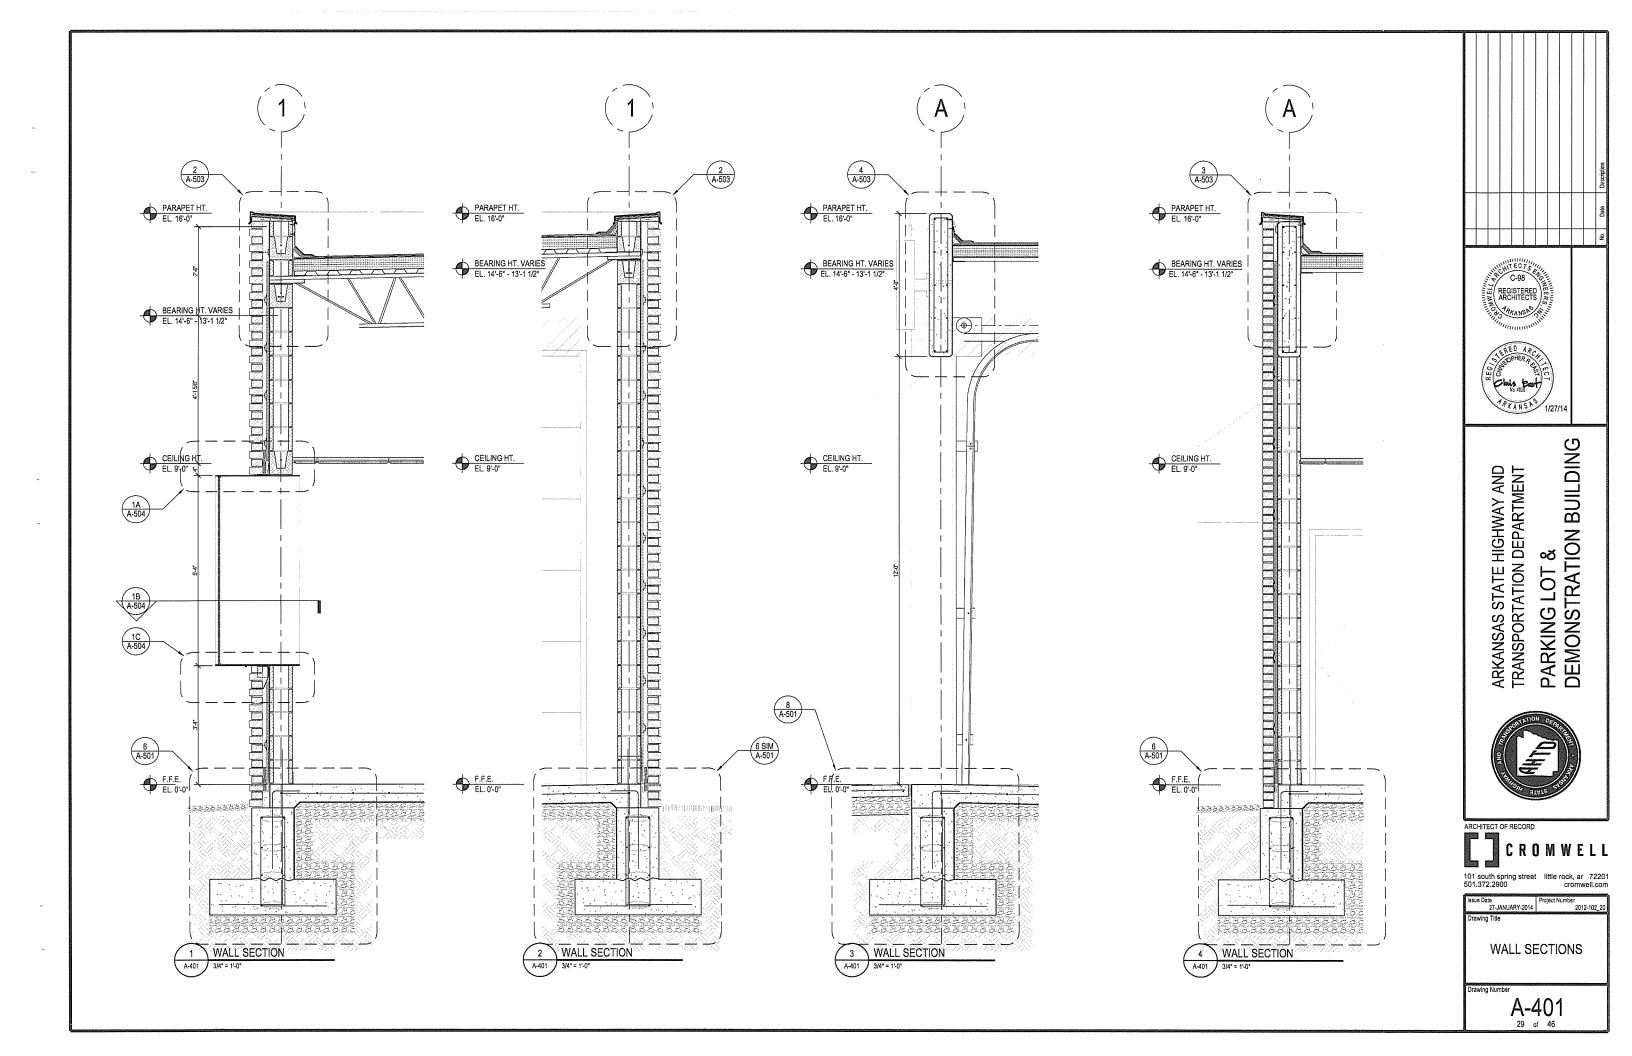
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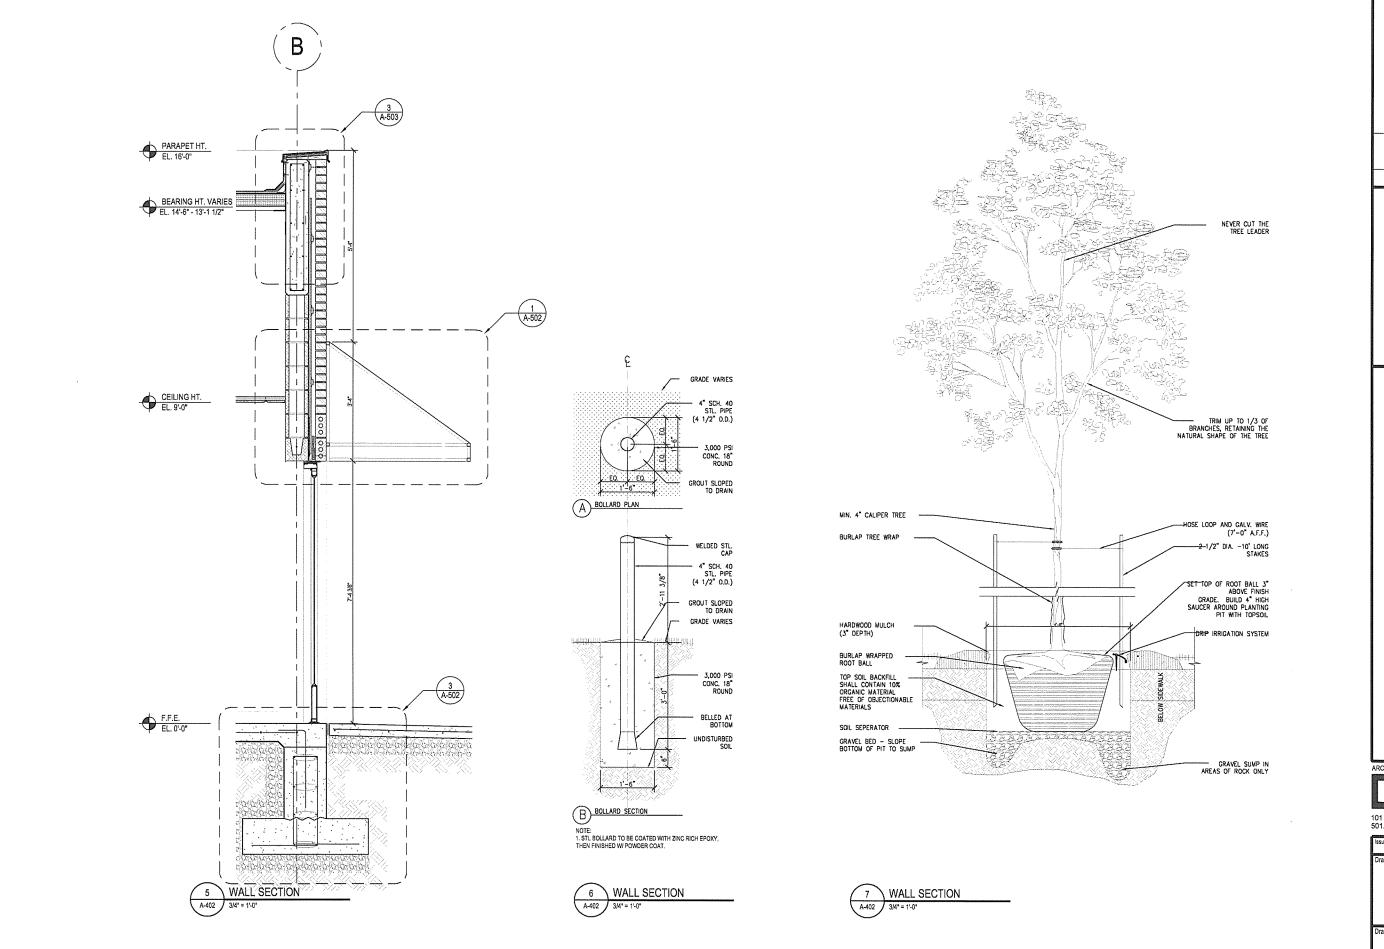
ssue Date Project Number 27-JANUARY-2014 2012-102_20

ROOF PLAN AND DETAILS





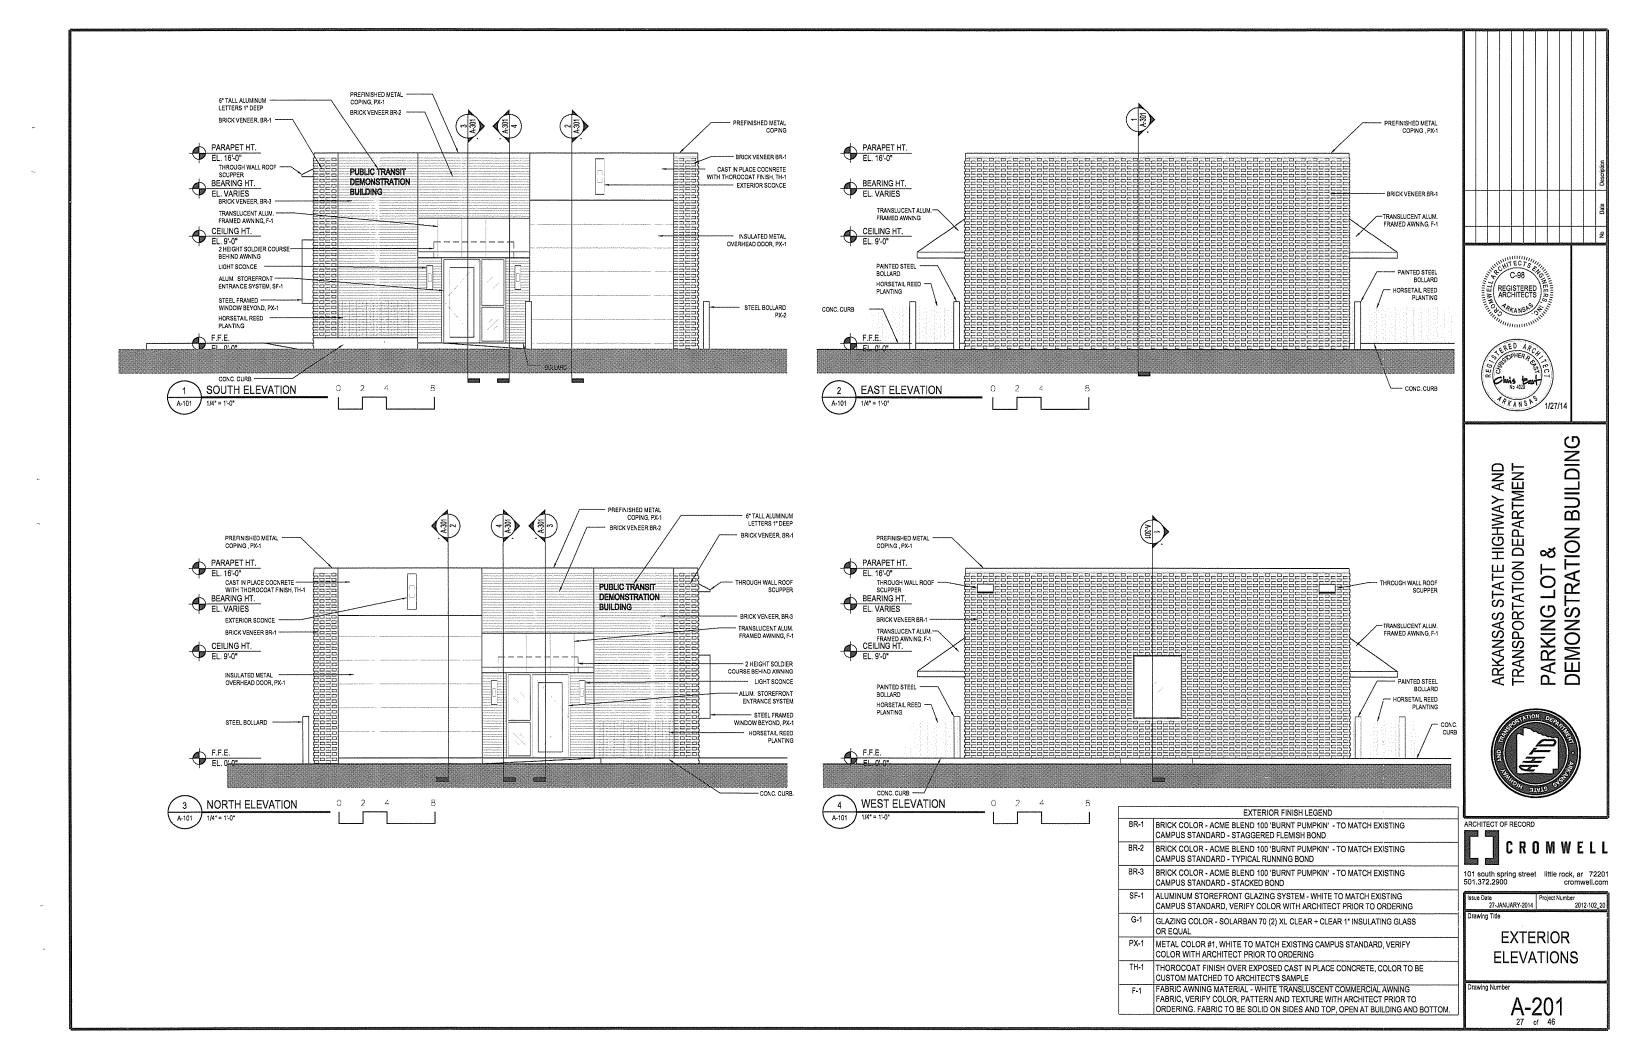

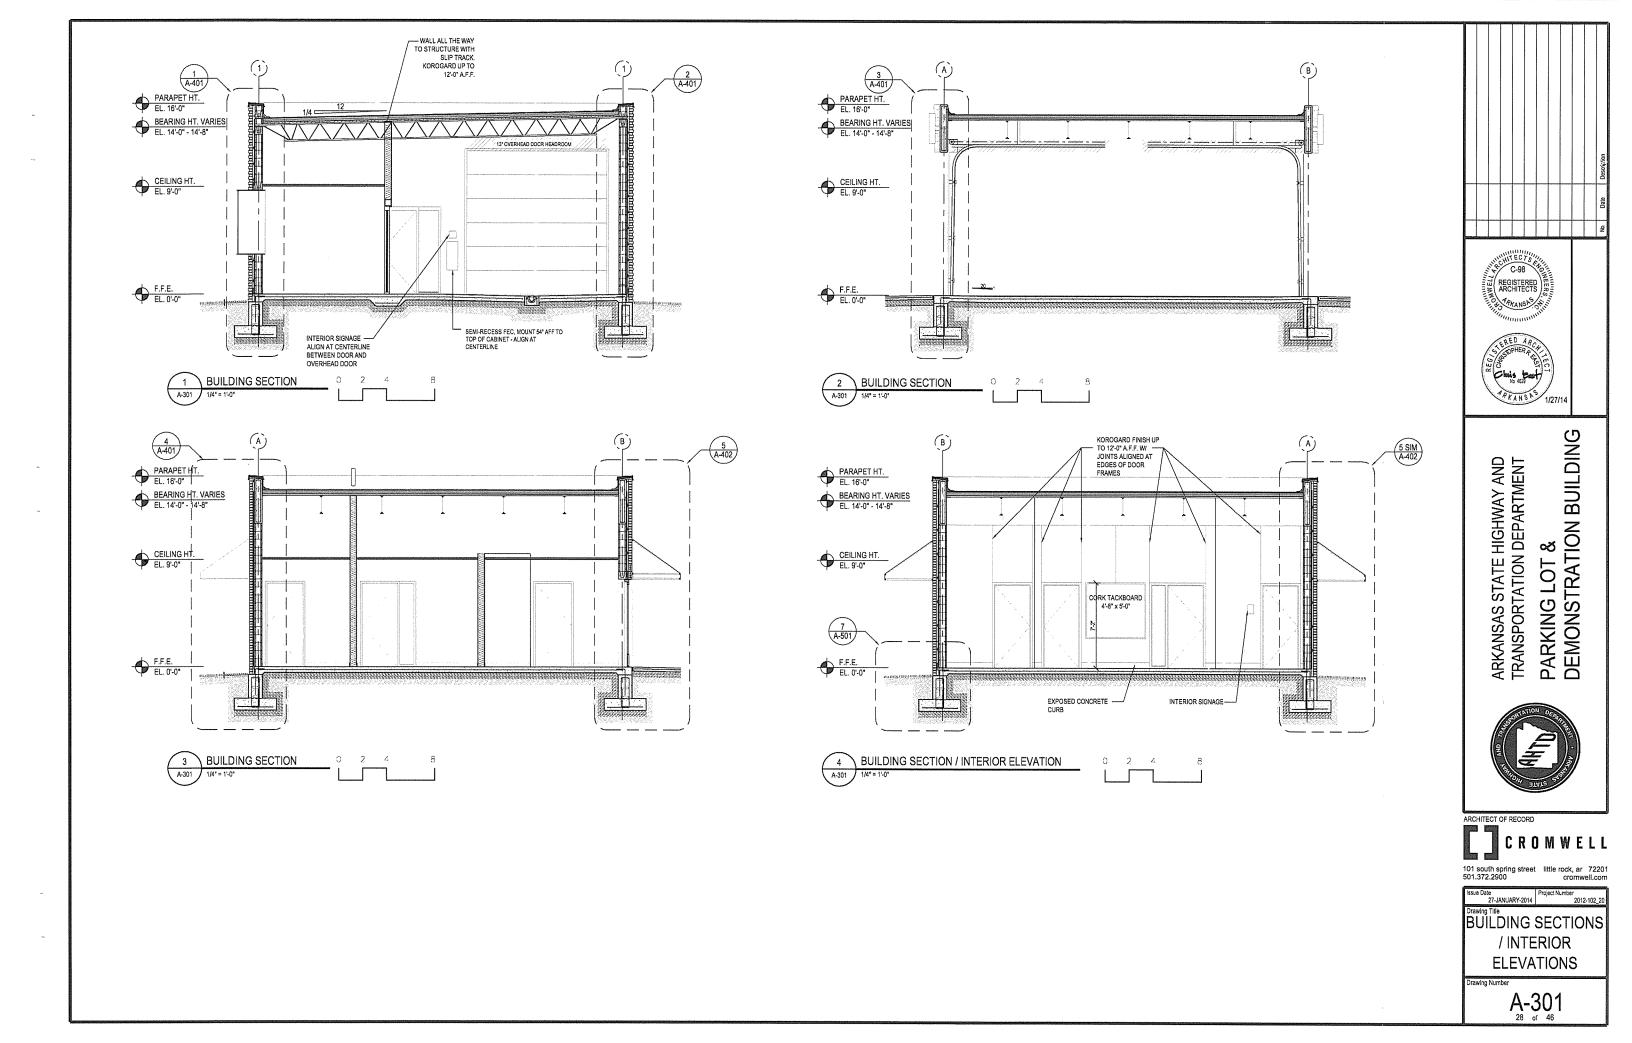







ARKANSAS STATE HIGHWAY AND TRANSPORTATION DEPARTMENT PARKING LOT & DEMONSTRATION BUILDING



ARCHITECT OF RECORD


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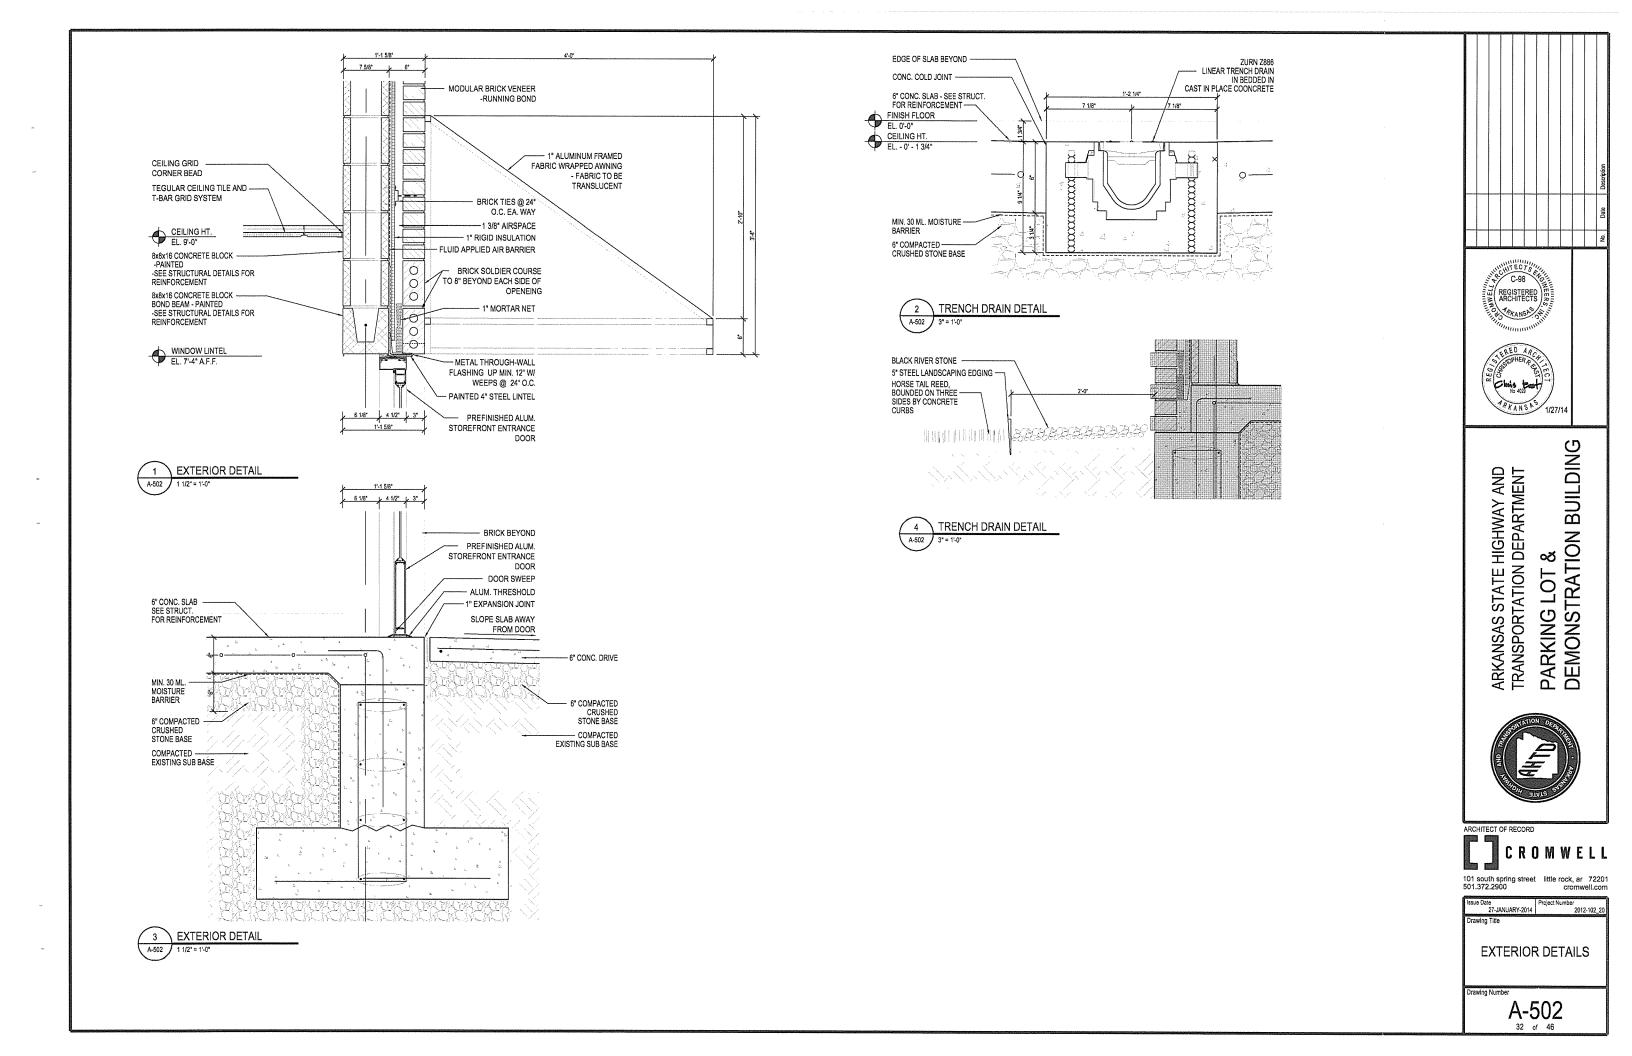
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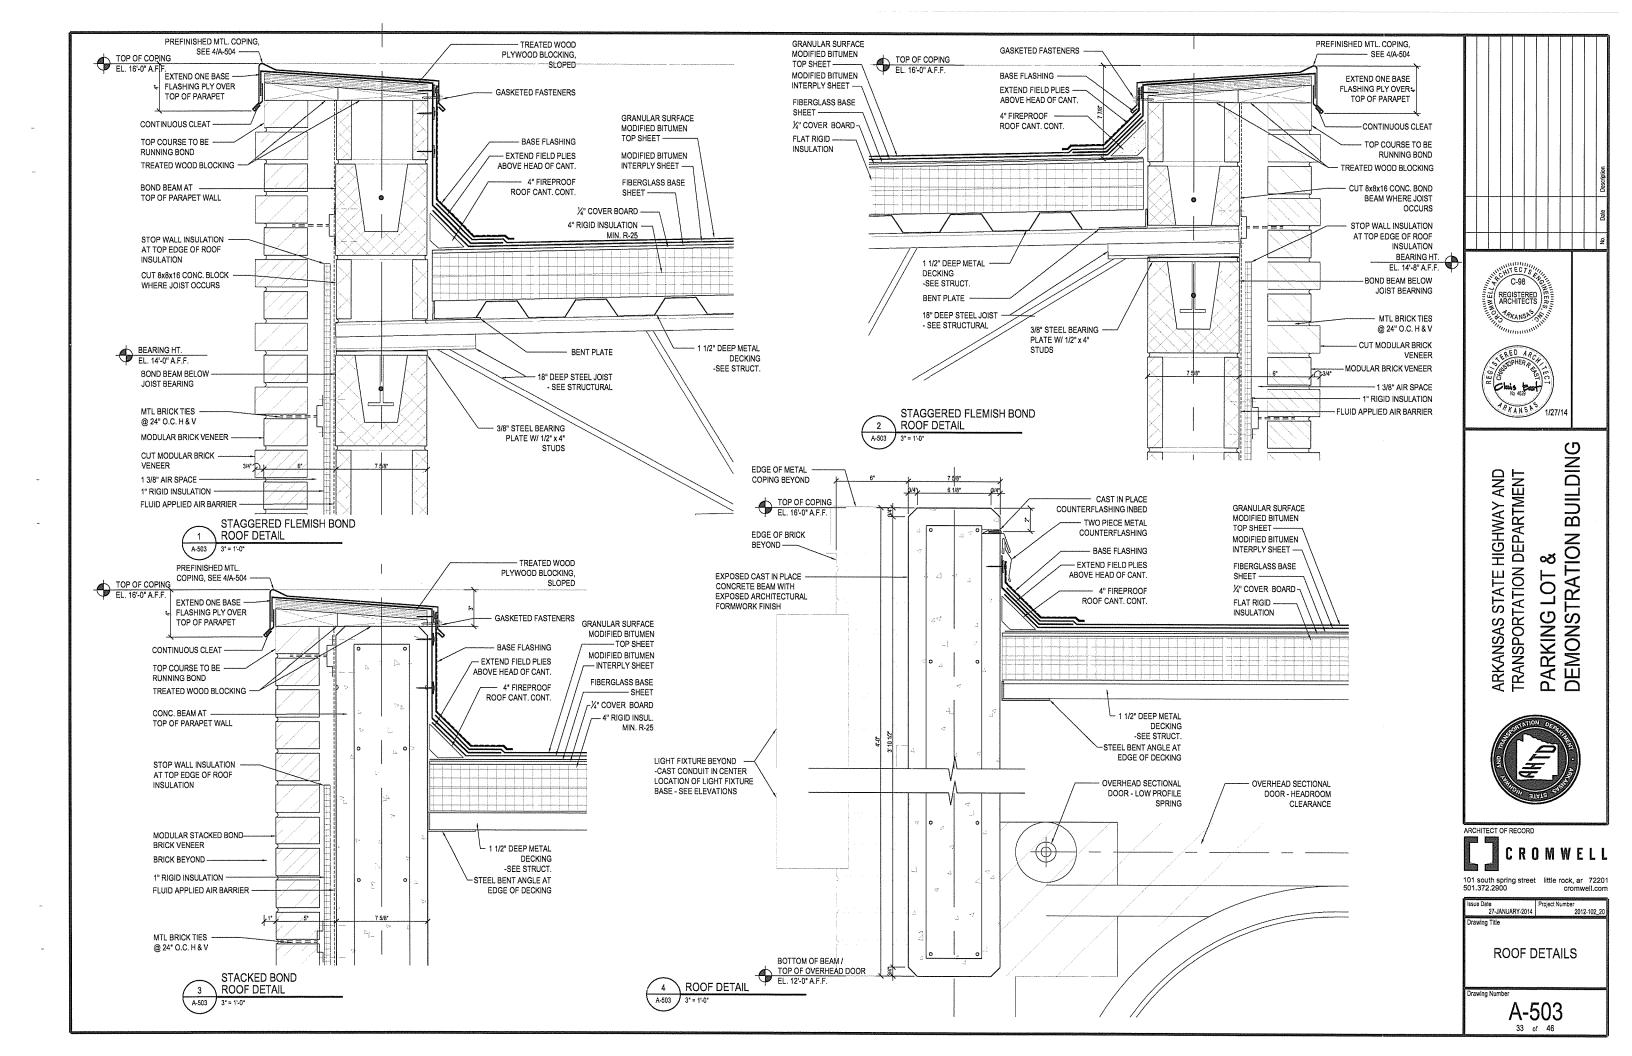
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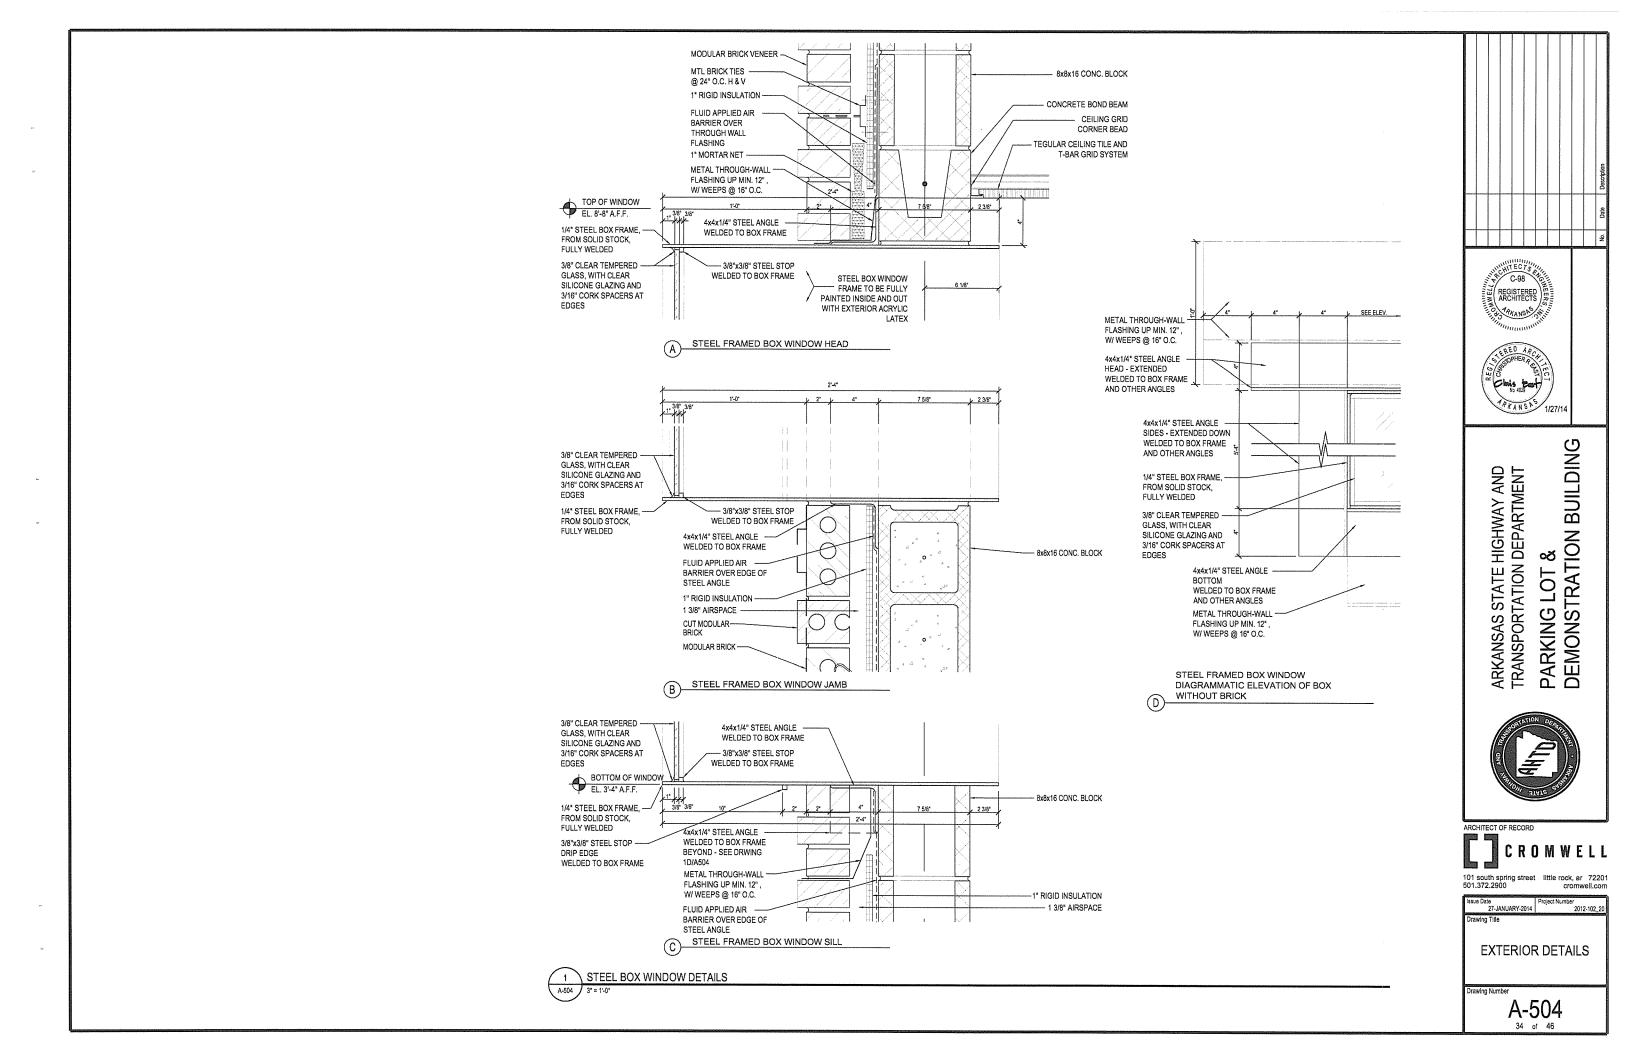
WALL SECTIONS


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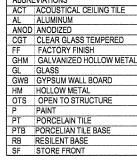











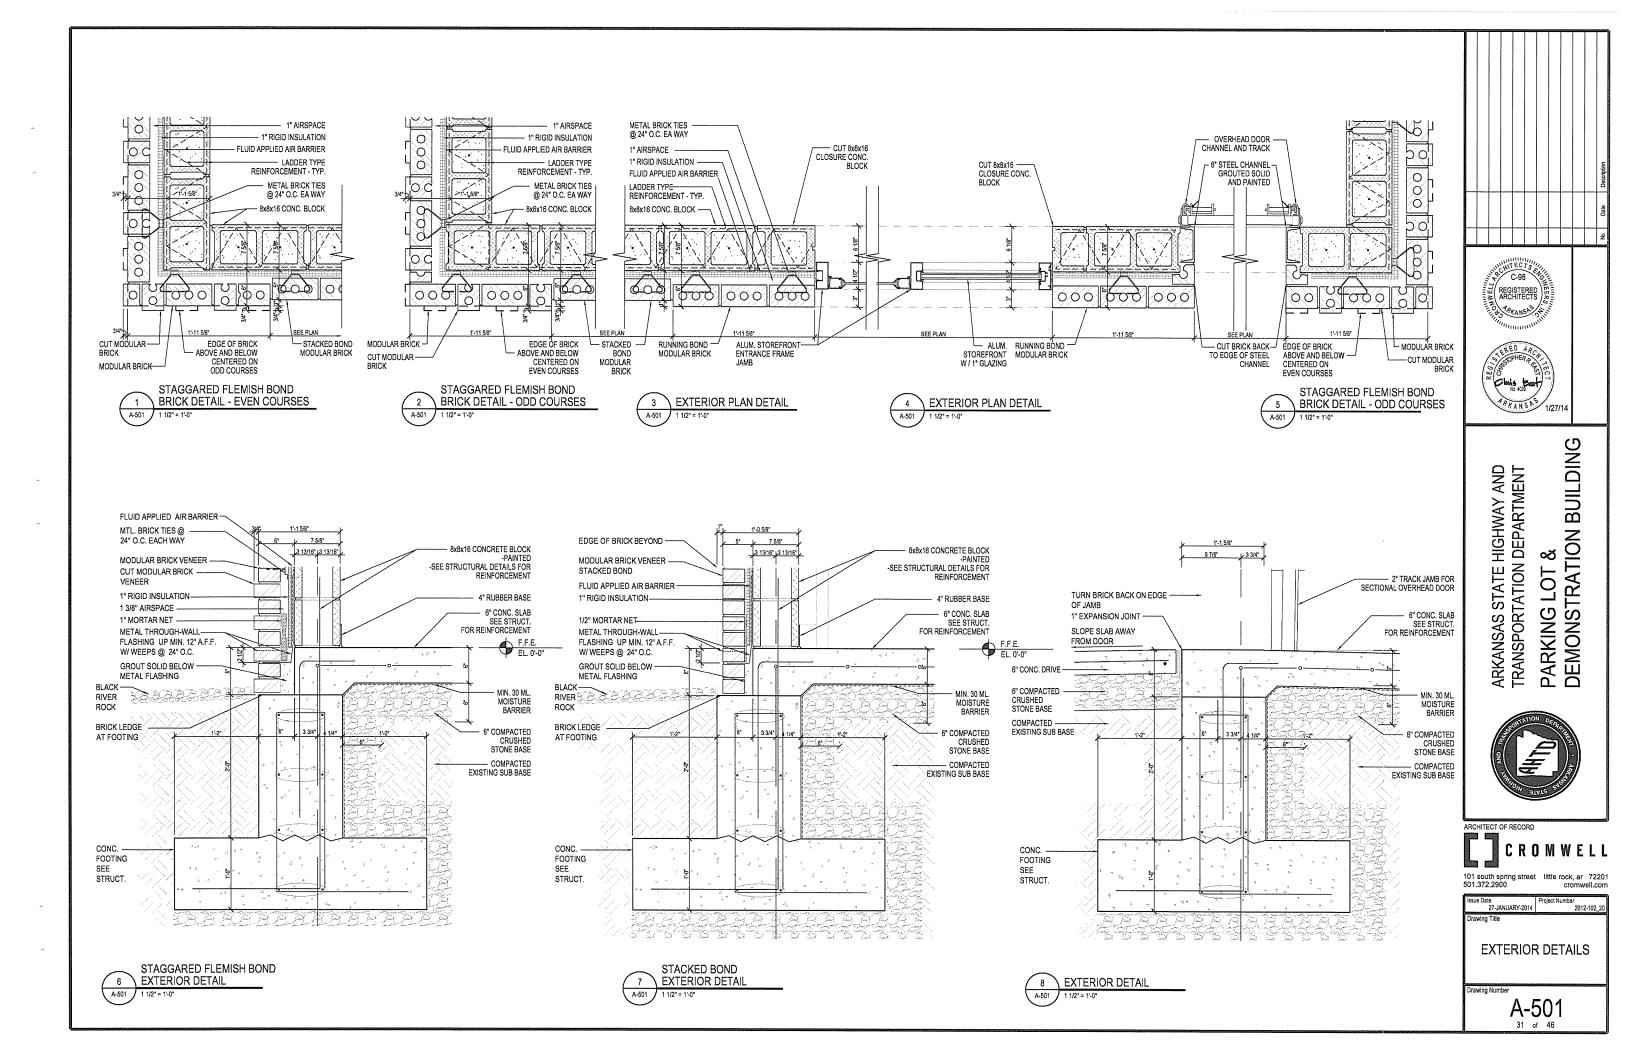


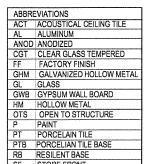

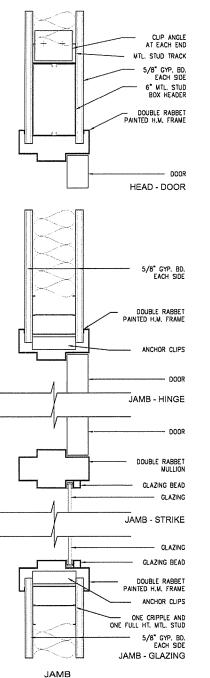

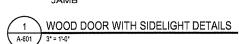


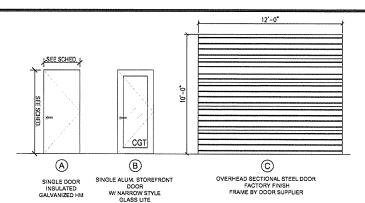

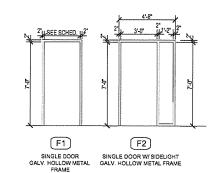

FRAME ELEVATIONS

A-401

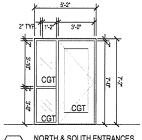

NOTES: 1. EXTERIOR GLAZING - PPG SOLARBAN 70 (2) CLEAR & CLEAR 2. GLASS TEMPERED WHEREVER REQUIRED BY CODE


ABBREVIATIONS: CG - CLEAR GLASS CGT- CLEAR GLASS TEMPERED

INTERIOR COLOR LEGEND

FIXED WINDOW STEEL FRAMED W/ CLEAR TEMPERED GLAZING

NORTH & SOUTH ENTRANCES (AL1) ANOD, ALUM, STOREFRONT SYSTEM KAWNEER TRIFAB 451T



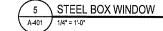


HADK	TVDE		SIZE			FINIOU	TVDE		DETA	IL	FIRE RATING	SET NO.	NOTES
MARK	TYPE	WD	НТ	THK	MAIL	FINISH	TYPE	MAIL	HD J	ΜВ	KAIING	NO.	
101A	В	3'-0"	7'-0"	1 3/4"	ALG	Р	AL-1	AL	1/A502 3/	A501		1	KEY CARD & POWER ASSIST O
101B	C	12'-0"	12'-0"	1 3/4"	MTL	P-1		MTL	4/A503 4/	A501			SEE SPECIFICATIONS
101C	C	12'-0"	12'-0"	1 3/4"	MTL	P-1		MTL	4/A503 4/	A501			SEE SPECIFICATIONS
102	В	3'-0"	7'-0"	1 3/4"	ALG	Р	AL-1	AL	1/A502 3/	A501		1	KEY CARD & POWER ASSIST O
103	A	3'-0"	7'-0"	1 3/4"	MTL	P-5	F-1	нм	1/A601 1/	A601	**	5	
104	A	3'-0"	7'-0"	1 3/4"	MTL	P-5	F-2	НМ	1/A601 1/	A601		3	•
105	Α	3'-0"	7'-0"	1 3/4"	MTL	P-5	F-1	НМ	1/A601 1/	A601		7	
106	В	3'-0"	7'-0"	1 3/4"	MTL	P-5	F-1	НМ	1/A601 1/	A601		5	••

RESTROOM

6" x 9"

B TOILET

WITH ADA

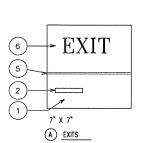

2 \ DOOR ELEVATIONS

A-401


KEYED SIGN NOTES:

A-401

- (1) %" CAST ACRYLIC PLAQUE WITH P-95 MATTE FINISH, SUBSURFACE PAINTED, COLOR AS SELECTED BY ARCHITECT
- (2) GRADE 2 BRAILLE EITHER RAISED ABOVE THE SURFACE OF THE PLAQUE OR ENGRAVED INTO THE ACRYLIC FACE. SURFACE APPLIED TAPES ARE NOT ACCEPTABLE.
- 3 4½" TALL PICTOGRAM RAISED 1/32".
- 4 %" TALL LETTERING RAISED ⅓2" FONT: HELVETICA

NO SCALE

SIGN SCHEDULE

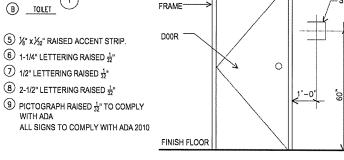

SIGN MOUNTING HEIGHT A-401 NO SCALE


ACT-	ADVICTION OF THE PROPERTY OF T
AC I	ARMSTRONG, 24" X 24" BEVELED TEGULAR ULTIMA #1911, PRELUDE XL 15/16" GR
FLOORS	
VCT-1	ARMSTRONG, STRIATIONS BBT, COLOR: T3603 TWILIGHT
PT-1	DALTILE, RITTENHOUSE SQUARE, 3" X 6" MATTE FIELD TILE, COLOR: ARCTIC WHITE #0190; INSTALL IN HORIZONTAL RUNNING BOND PATTERN
SC	SEALED CONCRETE
BASE	
₹8-1	JOHNSONITE, 4"H VINYL COVE BASE, COLOR: 20 CHARCOAL WG
PTB-1	DALTILE, RITTENHOUSE SQUARE, 3" X 6" COVE BASE AND CORNER, COLOR: ARCTIC WHITE #A-3361 AND L-3361
WALLS	
P-1	SHERWIN WILLIAMS, SHOJI WHITE #SW7042
P-2	SHERWIN WILLIAMS, GRIZZLE GRAY #SW7068 (TYPICAL TRIM PAINT)
P-3	SHERWIN WILLIAMS, BRASSY #SW6410
P-4	SHERWIN WILLIAMS, CHEERFUL #SW6903
P-5	SHERWIN WILLIAMS, RED TOMATO #SW6607
PT-1	DALTILE, RITTENHOUSE SQUARE, 3" X 6" MATTE FIELD TILE, COLOR: ARCTIC WHITE #0190; INSTALL IN HORIZONTAL RUNNING BOND PATTERN
K-1	KOROGARD WALLCOVERING 12' TALL SHEETS, COLOR 'VAPOR'


GENERAL FINISH NOTES

- 1. PROVIDE TRANSITION STRIPS AND THRESHOLDS FOR FLOOR CHANGES. CONTRACTOR TO PROVIDE SAMPLES TO A/E FIRM FOR APPROVAL AND COLOR SELECTION.
- 2. EPOXY GROUT TO BE USED ON PT-1 FLOOR AND PTB-1 TO MATCH LATICRETE #78 STERLING SILVER.
- 3. HOLLOW METAL DOOR FRAMES TO BE P-2, SEMI-GLOSS FINISH.
- TYPICAL WALL PAINT TO BE EGGSHELL FINISH, CEILING PAINT TO BE FLAT FINISH, EPOXY PAINT TO BE USED ON TOILET & DEMONSTRATION WALLS.
- 5. VCT FLOOR PATTERNS TO BE DETERMINED.

						ROOM FI	NISH S	CHEDULE	-					
	FLOOR BASE NORTH WALL SOUTH WALL EAST WALL											CEILING		
NUMBER	NAME	MATERIAL	MAT'L	MATERIAL	COLOR	MATERIAL COLOR		MATERIAL	COLOR	MATERIAL	COLOR	MATERIAL	COLOR	REMARKS
101	DEMONSTRATION	SC	RB-1	CMU	P-1	CMU	P-1	CMU	P-1	K-1, GYB	P-1	OTS	P-1	
102	ENTRY	sc	RB-1	CMU	P-1	СМИ	P-1			K-1, GYB	P-1	OTS	P-1	
103	STORAGE	VCT-1	RB-1	GWB	P-1	СМИ	P-1	GWB	P-1	CMU	P-1	ACT	ACT-1	
104	OFFICE	VCT-1	R8-1	GWB	P-1	GWB	P-1	GWB	P-1	CMU	P-4	ACT	ACT-1	
105	BATH	PT-1	PT-1	СМИ	P-3	PT-1		GWB	P-3	CMU	P-3	ACT	ACT-1	
106	JANITOR	SC	RB-1	GWB	P-1	GWB	P-1	GWB	P-1	GWB	P-1	ACT	ACT-1	
			<u> </u>						<u> </u>					

ROOM FINISH SCHEDULE A-401

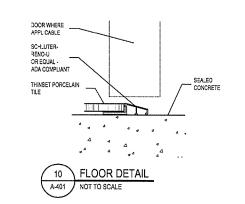

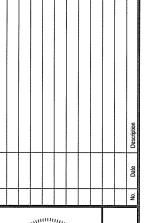





BUILDING ARKANSAS STATE HIGHWAY AND TRANSPORTATION DEPARTMENT PARKING LOT & DEMONSTRATION E



ARCHITECT OF RECORD CROMWELL

INTERIOR ELEVATIONS & SCHEDULES

PLUMBING LEGEND SYMBOL DESCRIPTION NEW COLD WATER NEW HOT WATER NEW SANITARY SEWER NEW VENT PRESSURE GAUGE WITH GAUGE COCK CHECK VALVE GATE VALVE GLOBE VALVE PLUG VALVE UNION FLOW - IN DIRECTION OF ARROW CONCENTRIC REDUCER 90° ELBOW 45° ELBOW BRANCH CONNECTION OUT OF SIDE BRANCH CONNECTION OUT OF TWO SIDES RISER DOWN (ELBOW) RISER UP (ELBOW) RISER UP (ELBOW) BRANCH CONNECTION OUT OF TOP BRANCH CONNECTION OUT OF BOTTOM BRANCH CONNECTION OUT OF BOTTOM BRANCH CONNECTION OUT OF TOP RISER DOWN TO 90° ELBOW 8 NEW PLUMBING FIXTURE WATER HAMMER ARRESTOR WHA-x (SUFFIX IS THE PDI RATING)

ADA REQUIREMENTS

THIS SECTION APPLIES TO HANDICAPPED ACCESSIBLE FIXTURES ONLY.

WATER CLOSETS: THE HEIGHT OF WATER CLOSETS SHALL BE 17"-19" MEASURED FROM THE TOP OF THE TOILET SEAT. SEATS SHALL NOT BE SPRUNG OR RETURN TO A LIFTED POSITION. THE WATER CLOSET SHALL BE LOCATED 18" FROM THE SIDE WALL TO THE CENTER OF THE BOWL, HAND OPERATED FLUSH CONTROLS SHALL BE MOUNTED ON THE WIDE SIDE OF THE TOILET AREAS NO MORE THAN 29" ABOVE FINISHED FLOOR. SEE ARCHITECTURAL SHEETS FOR GRAB BAR LOCATIONS


LAVATORIES: LAVATORIES SHALL BE MOUNTED WITH THE RIM OR COUNTER SURFACE NO MORE THAN 34" ABOVE FINISHED FLOOR, PROVIDE A CLEARANCE OF AT LEAST 29" ABOVE FINISHED FLOOR TO THE BOTTOM OF THE APRON. KNEE SPACE SHALL BE 8" FROM THE BOTTOM EDGE OF APRON TO THE LEADING EDGE OF THE BOTTOM OF BOWL. THE BOTTOM OF THE BOWL SHALL BE A MINIMUM OF 27" ABOVE FINISHED FLOOR, ALL

WATER AND DRAIN PIPING UNDER LAVATORIES SHALL BE INSULATED WITH FOAM INSERT, COVERED WITH A 1/8" VINYL OUTER SHELL, ANGLE STOPS SHALL HAVE A FLIP TOP ACCESS.

<u>DRINKING FOUNTAINS-WATER COLLERS:</u> WHEN INSTALLING A HI-LO ACCESSIBLE FOUNTAIN THE LOWEST SPOUT AT NO MORE THAN 36" ABOVE FINISHED FLOOR AND HIGH SPOUT AT 40" ABOVE FINISHED FLOOR. SPOUT SHALL BE AT THE FRONT OF THE UNIT AND SHALL DIRECT THE WATER FLOW IN A TRAJECTORY THAT IS PARALLEL OR NEARLY PARALLEL TO THE FRONT OF THE UNIT. THE SPOUT SHALL PROVIDE A WATER FLOW OF AT LEAST 4" HIGH. THE CONTROLS SHALL BE FRONT MOUNTED OR SIDE MOUNTED NEAR THE FRONT EDGE. CONTROLS SHALL BE OPERABLE WITH ONE HAND AND SHALL NOT REQUIRE TIGHT GRASPING, PINCHING OR TWISTING OF THE WRIST, THE FORCE REQUIRED TO ACYIVATE THE CONTROLS SHALL BE NO GREATER THAN 5 lbf. WALL MOUNTED UNITS SHALL HAVE A CLEAR KNEE SPACE BETWEEN THE BOTTOM OF THE APRON AND THE FINISHED FLOOR OF 27" HIGH, AND 17"-19" DEEP. FOUNTAINS SHALL NOT PROTRUDE MORE 4" INTO WALKWAY.

GENERAL NOTES

- 1ALL PLUMBING SYSTEMS SHALL BE INSTALLED AS PER SPECIFICATIONS AND GOVERNING CODES.
- ALL DRAWINGS ARE DIAGRAMMATIC AND INDICATE THE GENERAL ARRANGEMENTS OR GEOMETRIC RELATIONSHIPS OF EQUIPMENT AND SERVICES. THEY ARE NOT INTENDED TO SPECIFY OR SHOW EVERY OFFSET, FITTING OR COMPONENT. CONTRACTOR SHALL NOT SCALE DRAWINGS. INFORMATION AND COMPONENTS SHOWN ON RISER DIAGRAMS OR DETAILS, BUT NOT SHOWN ON PLANS, AND VICE-VERSA, SHALL BE PROVIDED AS IF EXPRESSLY REQUIRED BY BOTH. THE CONTRACTOR SHALL SUBMIT A REQUEST FOR INFORMATION (RFI) IF INFORMATION CONFLICTS. DRAWINGS SPECIFIC TO THIS DISCIPLINE DO NOT LIMIT THE RESPONSIBILITY OF WORK REQUIRED BY CONTRACT DOCUMENTS. REFER TO ARCHITECTURAL. STRUCTURAL. ELECTRICAL AND OTHER DRAWINGS FOR COMPLETE INFORMATION
- BY NECESSITY, THESE DRAWINGS REFLECT A SYSTEM DESIGNED AROUND SPECIFIC REFERENCE PRODUCTS, THE SELECTION OF WHICH HAS IMPACTED THE DESIGNS OF OTHER TRADES (HVAC, ELECTRICAL, STRUCTURAL, ETC.). IF ALTERNATE MANUFACTURERS, FUEL SOURCES, SIZES, OR MODEL NUMBERS ARE SUBMITTED OR BID, IT IS THE RESPONSIBILITY OF THE GENERAL CONTRACTOR AND ALL SUBCONTRACTORS TO COORDINATE ALL DIFFERENCES PRIOR TO BID. NO EXTRAS WILL BE ALLOWED FOR CHANGES REQUIRED TO OTHER TRADES IF ALTERNATE EQUIPMENT IS BID OR INSTALLED AT THE CONTRACTORS OPTION
- EXCEPT WHERE MODIFIED BY SPECIFIC NOTATION TO THE CONTRARY, IT SHALL BE UNDERSTOOD THAT THE INDICATION AND/OR DESCRIPTION OF ANY ITEM, IN THE DRAWINGS OR SPECIFICATIONS OR BOTH, CARRIES WITH IT THE INSTRUCTION TO FURNISH AND INSTALL THE ITEM, REGARDLESS OF WHETHER OR NOT THIS INSTRUCTION IS EXPLICITLY STATED AS PART OF THE INDICATION OR DESCRIPTION
- CONTRACTOR SHALL PAY ALL UTILITY FEES & CHARGES AS PART OF BASE BID IN THE CONTRACT.
- THE CONTRACTOR SHALL BE RESPONSIBLE FOR COORDINATING ALL WORK WITH THAT OF OTHER TRADES; i.e., ARCHITECTURAL, HVAC, ELECTRICAL, STRUCTURAL, FIRE PROTECTION AND CIVIL PRIOR TO CONSTRUCTION.
- THE CONTRACTOR SHALL COORDINATE EXISTING UTILITY LOCATIONS, SIZES AND INVERT ELEVATIONS PRIOR TO CONSTRUCTION; i.e., SANITARY SEWER, STORM DRAIN, FIRE PROTECTION AND DOMESTIC WATER SERVICES AS IT PERTAINS TO THIS PROJECT.
- PROVIDE ISOLATION VALVES AT EACH FIXTURE GROUP OR BATTERY OF FIXTURES IN THE DOMESTIC CW, HW AND HWR PIPING. VALVES SHALL BE EASILY ACCESSIBLE. WHERE HARD CEILINGS ARE LOCATED, VALVES SHALL BE ACCESSED THROUGH ACCESS PANELS. ACCESS PANELS SHALL BE COORDINATED WITH ARCHITECT PRIOR TO
- PROVIDE STOP VALVES AT ALL PLUMBING FIXTURES ON BOTH HOT AND COLD WATER SUPPLY LINES. VALVES, ESCUTCHEONS, FITTINGS, ETC., SHALL BE CHROME PLATED AND INSTALLED TIGHT TO WALL. WHERE PIPING IS EXPOSED, CHROME PLATED PIPE SHALL BE USED.
- 10. ALL EXPOSED OR ACCESSIBLE P-TRAPS SHALL BE CHROME PLATED AND PROVIDED WITH BOTTOM CLEANOUT PLUGS.
- 11. SLOPE 21/2" AND SMALLER DRAIN WASTE AND VENT (DWV) LINES AT MIN, (2%) 1/4" FALL PER FT., 3" TO 6" DWV LINES AT MIN. (1%) 1/8" FALL PER FT. AND 8" AND LARGER DWV LINES AT MIN. (.5%) 1/16* FALL PER FT. SANITARY SEWER AND WATER SHALL BE A MINIMUM OF 10' APART OR THE DOMESTIC WATER SERVICE SHALL BE 12" ABOVE THE TOP OF THE SEWER LINE, AT ITS HIGHEST POINT, IF PLACED IN SAME TRENCH
- 12. PROVIDE ALL FITTINGS, TRANSITIONS, COUPLINGS, ADAPTERS, UNIONS, AND OTHER ACCESSORIES NEEDED TO COMPLETE CONNECTIONS AND PROPER OPERATIONS OF PLUMBING FIXTURES AND PLUMBING EQUIPMENT
- REFER TO SPECIFICATIONS FOR ACCEPTABLE MANUFACTURERS OF PLUMBING FIXTURES AND EQUIPMENT, AND PROPER APPLICATIONS OF SAME.
- 14. PROVIDE CLEANOUTS IN ALL SEWERS, WHETHER SHOWN OR NOT, AT INTERVALS NOT TO EXCEED 50 FEET, AT EACH CHANGE OF DIRECTION GREATER THAN 45 DEGREES, AND ALL VERTICAL STACKS AT A HEIGHT OF 30" ABOVE FINISH FLOOR AT THE BASE OF EACH STACK.
- 15. DO NOT ROUTE ANY PIPING OVER ELEC. ROOMS, COMPUTER ROOMS, OR ELEC. PANELS.
- ALL DOMESTIC WATER PIPING ROUTED IN AREAS SUBJECT TO FREEZING TEMPERATURES SHALL BE ROUTED BELOW INSULATION AND WITHIN THE HEATED ENVELOPE OF THE BUILDING. WHERE PIPING CAN NOT BE ROUTED BELOW INSULATION, PIPING SHALL HAVE 5 WATT/FT HEAT TRACING ATTACHED. SEE ARCHITECTURAL DRAWINGS FOR INSULATION PLACEMENT AND DETAILS. COORDINATE ELECTRICAL REQUIREMENTS WITH ELECTRICAL CONTRACTOR AND ENGINEER
- 17. UNLESS OTHERWISE INDICATED DO NOT ROUTE WATER PIPING IN EXTERIOR WALLS. WHEN ROUTED IN EXTERIOR WALLS, CAREFULLY POSITION WATER PIPING ON THE HEATED SIDE (INTERIOR SIDE) OF THE WALL INSULATION
- MAINTAIN 10'-0" MINIMUM CLEARANCE BETWEEN FRESH AIR INTAKES, OPERABLE WINDOWS AND FLUES, PLUMBING VENTS AND GAS REGULATORS.
- 19. ALL STORM DRAIN, CONDENSATE DRAIN, SEWER & VENT PIPING SHALL BE RODDED AND CLEANED AT END OF CONSTRUCTION. ALL TRAPS SHALL BE CLEANED AND PRIMED AT END OF CONSTRUCTION
- 20. ALL PIPE DROPS FROM CEILING PLENUM TO FLOOR SHALL BE MADE IN FURROUTS AT COLUMNS, IN WEB OF BEAMS AT COLUMNS OR IN WALLS. PIPING SHALL BE CONCEALED UNLESS APPROVED BY ARCHITECT
- PROVIDE WATER HAMMER ARRESTORS IN FIXTURE BRANCHES WHERE QUICK CLOSING VALVES ARE INSTALLED; i.e., FLUSH VALVES, ICE MAKERS, DISHWASHERS, ETC.
- 22. BELOW SLAB WATER PIPE TO BE TYPE K SOFT DRAWN COPPER WITHOUT FITTINGS OR JOINTS. SLEEVE IN ENTIRETY WITH ARMAFLEX OR APPROPRIATE POLYETHYLENE
- 23. PROVIDE APPROVED BACKFLOW PREVENTION OR ANTI-SIPHON DEVICES AT ALL FIXTURES THAT COULD CONTAMINATE THE POTABLE WATER SYSTEM.
- INSULATE ALL WATER, CONDENSATE, STORM DRAIN PIPING (VERTICAL AND HORIZONTAL) AND ROOF DRAIN BODIES ABOVE FINISH FLOOR, SEE SPECIFICATIONS FOR THICKNESS SCHEDULE.
- 25. INSULATE ALL EXPOSED HOT WATER & DRAIN PIPING FOR ACCESSIBLE FIXTURES PER ANSI A117.1 AND ADA REQUIREMENTS.
- 26. AN APPROVED TRAP GUARD PRODUCT CONFORMING TO NSF-14, CSAB602-99 AND CSAB79-94 SHALL BE INSTALLED AT ALL FLOOR AND HUB DRAINS. ALL DRAINS SHALL HAVE DEEP SEAL TRAPS, 4" DEEP SEAL MINIMUM. INSTALL TRAP GUARD DEVICES PER MANUFACTURER'S INSTRUCTIONS.
- PER ARKANSAS PLUMBING CODE (2006 EDITION) SECTION 705.18 JOINTS BETWEEN DIFFERENT MATERIALS STATES THAT "JOINTS BETWEEN DIFFERENT PIPING MATERIAL SHALL BE MADE WITH MECHANICAL JOINT OF THE COMPRESSION OR MECHANICAL-SEALING TYPE CONFORMING TO ASTM C 1473, ASTM C 1460 OR ASTM C 1661. CONNECTORS AND ADAPTERS SHALL HAVE AN ELASTOMERIC SEAL CONFORMING TO ASTM C 425, ASTM C 443, ASTM C 564, ASTM C 1440, ASTM D 1869, ASTM F 477, CSA 2257.3M OR CSA 8602, OR AS REQUIRED IN SECTIONS 705 18 1 THRU 705 18 7

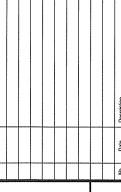





BUILDIN ARKANSAS STATE HIGHWAY AND TRANSPORTATION DEPARTMENT DEMONSTRATION LOT ARKING \Box




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27-JANUARY-2014 PLUMBING LEGEND AND **GENERAL NOTES**

P-00'

NOTE: ALL SYMBOLS MAY NOT BE USED.




LEGEND AND NOTES

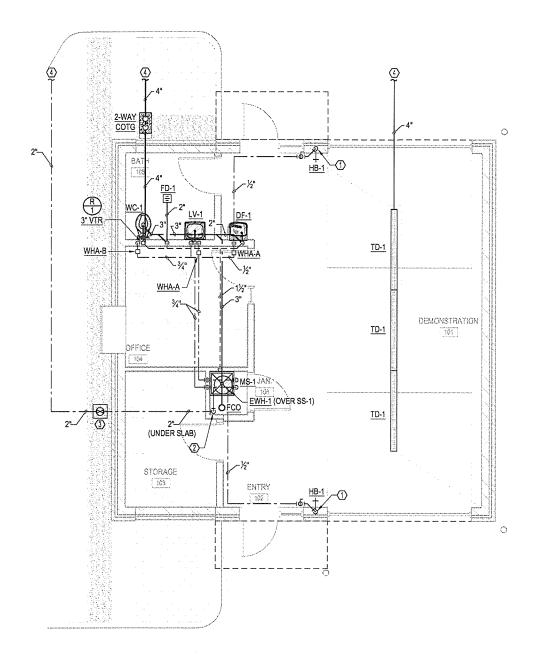REFER TO SHEET P-001 FOR LEGEND AND NOTES.


PLUMBING PLAN - KEYED NOTES

- (1) CW LINE DN IN WALL TO A HOSE BIBB AT 24" A.F.F.
- (2) RISE IN WALL WITH DOMESTIC CW LINE TO ABOVE CEILING AND CONTINUE AS SHOWN.
- 3 PROVIDE A DOMESTIC WATER SHUT-OFF VALVE IN A CAST-IRON VALVE BOX WITH A CAST-IRON DROP COVER MARKED "WATER".
- 4 RE: SITE UTILITY PLAN FOR CONTINUATION.

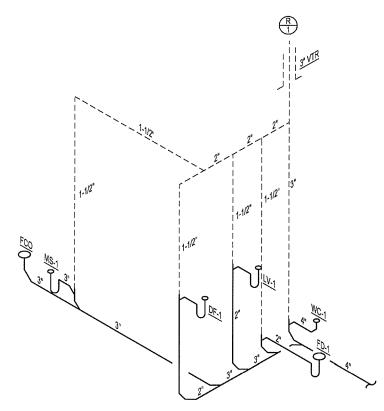

PLUMBING WASTE AND VENT RISER



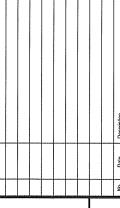





ARKANSAS STATE HIGHWAY AND TRANSPORTATION DEPARTMENT PARKING LOT & DEMONSTRATION BUILDING



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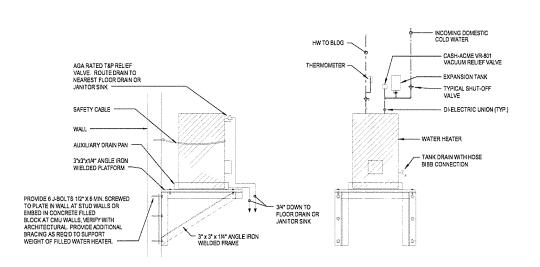
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Issue Date 27-JANUARY-2014 Project Number 2012-1
Drawing Title


PLUMBING PLAN AND RISER

Drawing Numbe


P-101




1 ELECTRIC WATER HEATER WITH MIXING VALVE NO SCALE

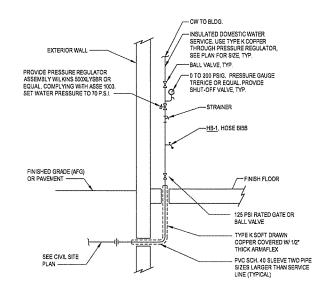


2 DOMESTIC WATER SERVICE RISER NO SCALE

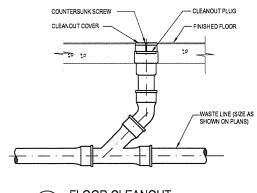

3 FLOOR CLEANOUT

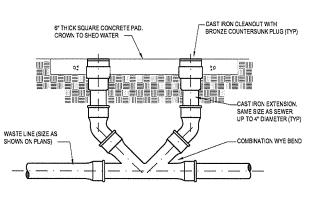


DOUBLE CLEANOUT-TO-GRADE

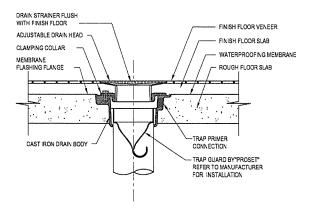

TRAP GUARD INSTALLATION

NO SCALE

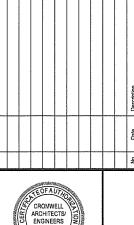





ARKANSAS STATE HIGHWAY AND TRANSPORTATION DEPARTMENT PARKING LOT & DEMONSTRATION BUILDING



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27-JANUARY-2014 Projec: Number
2012-102_20
Drawing Title

PLUMBING DETAILS

Drawing Number

P-501

PLUMBING FIXTURE SCHEDULE

WC-1 WATER CLOSET, FLOOR-MOUNTED, SENSOR FLUSH VALVE, ADA ACCESSIBLE FIXTURE - AMERICAN STANDARD "MADERA" #3461.001 (BOWL ONLY) WITH EVERCLEAN, VITREOUS CHINA, WHITE, FLOOR MOUNTED, ELONGATED BOWL, 1.28 GPF, FULLY GLAZED 2-1/8" PASSAGEWAY, 1-1/2" INLET SPUD, SIPHON JET FLUSHING, AND INTEGRAL TRAPS. TOILET SEAT - AMERICAN STANDARD #5901.110 WITH EVERCLEAN, ELONGATED SEAT OPEN FRONT WITH NO COVER, WHITE.

FLUSH VALVE - SLOAN OPTIMA PLUS #8111- 1.28 GPF, BATTERY POWERED INFRARED SENSOR, COURTESY OVER-RIDE BUTTON, VACUUM BREAKER, EXPOSED CHROME PLATED, FLUSHOMETER, VANDAL RESISTANT STOP CAP.

PLUMBING ROUGH-INS - 4" SS, 2" V, 1" CW

MOUNTING HEIGHT - SEE ADA COMPLIANT NOTES FOR ADDITIONAL REQUIREMENTS

LV-1 LAVATORY - WALL HUNG - ADA COMPLIANT FIXTURE - AMERICAN STANDARD "LUCERNE" #0356.421, VITREOUS CHINA, 20-1/2" X 18-1/4", WALL HUNG, CONCEALED ARMS, WHITE IN COLOR.

WALL DIVING, OTWOCHAELD ANNAS, WHITE IN OCCUR.

FAUCET - CHICAGO FAUCET #118.202.AB.1, BATTERY POWERED INFRARED SENSOR, SINGLE HOLE, .5 GPM LOW FLOW, VANDAL RESISTANT AERATOR. INSTALL HIGH AND TIGHT BELOW FIXTURE TO CONCEAL

MIXING VALVE - LAWLER #TMM-1070, BELOW DECK MECHANICAL THERMOSTATIC MIXING VALVE (SET @ 115°F).

GRID STRAINER - McGUIRE #155WC OFFSET TYPE, 1-1/4".

STOPS - McGUIRE #2165CCLK, LOOSE KEY, COMPRESSION CONNECTION, 1/2"x3/8" O.D. P-TRAP - McGUIRE #8872, 1-1/4" INLET/OUTLET, 17 GA. CHROME PLATED CAST BRASS WITH CLEANOUT.

COVERS - TUREBRO PRODUCTS TRAP AND SUPPLY COVERS. (LESS COVERS AT NON-ADA, SEE ARCHITECTURAL).

CARRIER - WADE 520-M24

PLUMBING ROUGH-INS - 2" SS, 2" V, 1/2" CW, 1/2" HW

MOUNTING HEIGHT - SEE ADA COMPLIANT NOTES FOR ADDITIONAL REQUIREMENTS.

MS-1 MOP SINK, FLOOR MOUNT

FIXTURE - STERN-WILLIAMS #MTB-2424, 24" X 24" X 10", TERRAZZO RECEPTOR WITH STAINLESS STEEL CAPS.

FAUCET - #T-10-VB ROUGH CHROME PLATED FAUCET WITH VACUUM BREAKER AND PAIL HOOK, MOUNTED 36" AFF, #T-35, 36" RUBBER HOSE AND HOSE HANGER. ACCESSORIES - #T-40 STAINLESS STEEL MOP HANGER, (2) #BP STAINLESS STEEL SPLASH PANELS, CAULK JOINTS BETWEEN SINK AND WALL WITH SILICONE SEALANT PLUMBING ROUGH-INS - 3" SS, 2" V, 1/2" CW, 1/2" HW

<u>DF-1 DRINKING FOUNTAIN (ADA COMPLIANT)</u>
<u>FIXTURE</u> - OASIS #M110PM, NON-REFRIGERATED DRINKING FOUNTAIN, STAINLESS STEEL BUBBLER, STAINLESS STEEL CABINET, ANSI A117.1.

STOP - McGUIRE #ST17LK, LOOSE KEY, COMPRESSION CONNECTION, 1/2"x3/8" O.D. P-TRAP - McGUIRE #8872, 1-1/4" INLET/OUTLET, 17 GA. CHROME PLATED CAST BRASS WITH

CARRIER - WADE #440 SERIES FLOOR MOUNTED CARRIER.

PLUMBING ROUGH-INS - 2" SS, 2" V, 1/2" CW

MOUNTING HEIGHT - SEE ADA COMPLIANT NOTES FOR ADDITIONAL REQUIREMENTS.

FIXTURE - ZURN #Z1334-C WITH VACUUM BREAKER BACKFLOW PREVENTER, 3/4" HOSE THREAD NOZZLE, LOOSE TEE KEY HANDLE.

PLUMBING ROUGH-INS - 3/4" CW

FD-1 FLOOR DRAIN

FIXTURE - EQUAL TO WADE #W-1100TS, CAST IRON FLOOR DRAIN WITH FLANGE, INTEGRAL CLAMPING COLLAR, SEEPAGE OPENING, ROUND ADJUSTABLE HEAVY DUTY CAST IRON 7" DIAMETER NICKEL BRONZE STRAINER WITH VANDAL PROOF SCREWS, WITH DEEP-SEAL TRAP. PROSET SYSTEM TRAP GUARD INSERT, SEE PLAN FOR SIZE. PLUMBING ROUGH-INS - 2", 3", 4" SS, 2" V

TD-1 TRENCH DRAIN

FIXTURE - EQUAL TO ZURN #Z886-BG, HDPE MODULAR CHANNEL TRENCH DRAIN, INTEGRAL ANCHORS AT 10" O.C. FOR CASTING INTO CONCRETE SLAB, 1-1/2" RADIUSED BOTTOM WITH MANNING'S N=0.009 AND INTEGRAL CONTINUOUS SLOPE OF 0.75%, AND TRAFFIC RATED CLASS C GALVANIZED DUCTILE IRON GRATE.

FCO FLOOR CLEANOUT

FIXTURE - ZURN #ZN1400-HD SERIES ADJUSTABLE, HEAVY DUTY CAST IRON FLOOR OUTLET, BRONZE PLUG, POLISHED NICKLE BRONZE TOP AND

COTG CLEANOUT TO GRADE

FIXTURE - ZURN #Z-1400-HD-BP-VP CAST IRON CLEANOUT WITH THREADED ADJUSTABLE HOUSING, FLANGED FERRULE WITH PLUG, AND ROUND CAST IRON TRACTOR TOP.


PLUMBING ROUGH-INS - SEE PLANS

WATER HAMMER ARRESTORS

FIXTURE - EQUAL TO WADE "SHOKTROL" WHERE REQUIRED IN PIPING SYSTEMS, PROPERLY SIZED WATER HAMMER ARRESTORS SHALL BE PROVIDED. WATER HAMMER ARRESTERS SHALL BE LOCATED ON ALL QUICK CLOSING VALVES (FLUSH VALVES, DISHWASHERS, ICE MAKERS, ETC.)

EWH-1 DOMESTIC WATER HEATER, ELECTRIC WATER HEATER EQUAL TO RHEEM #EGSP10, 10 GALLON STORAGE CAPACITY, 2.5 KW INPUT, 208V/1 PHASE, 17 GPH CONTINUOUS RECOVERY AT 60°F RISE, SURFACE THERMOSTATS, SEAMLESS GLASS-LINED TANK, 150 PSI WORKING PRESSURE, HIGH LIMIT CUT-OFF. WARRANTIES: 3-YEAR LIMITED/1 YEAR PARTS. EXPANSION TANK - ET-1 - EQUAL TO AMTROL "THERM-X-TROL" #ST-5, 2.0 GALLONS TOTAL SYSTEM VOLUME, 150 PSI MAXIMUM WORKING PRESSURE. PRESSURE, 8"Ø X 12-5/8" HT, 3/4" NPT, 5 LBS. PROVIDE BALL VALVE TO

WATER HAMMER ARRESTOR											
WADE SHOKTROL SIZE	#5	#10	#20	#50	#75	#100					
P.D.I. UNITS	A	В	С	D	E	F					
FIXTURE UNITS	1-11	12-32	33-60	61-113	114-154	155-330					

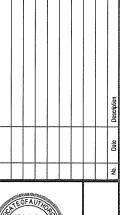





BUILDING ARKANSAS STATE HIGHWAY AND TRANSPORTATION DEPARTMENT PARKING LOT & DEMONSTRATION E



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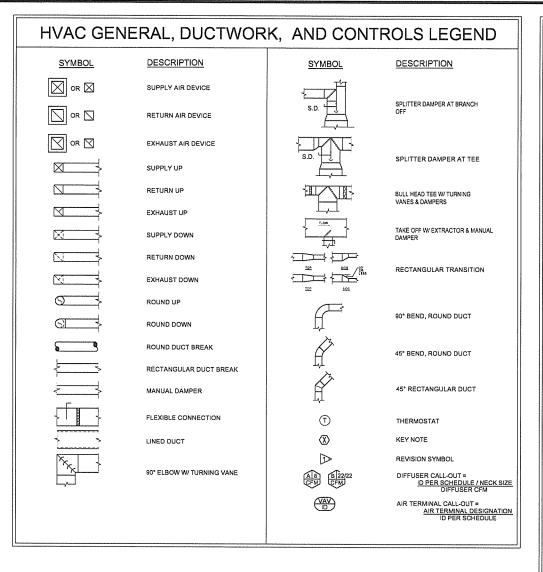
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Issue Date 27-JANUARY-2014 2012-102_20 **PLUMBING**

P-601

SCHEDULE

DESCRIPTION	ABBREVIATION	DESCRIPTION	ABBREVIATION
ABOVE FINISH FLOOR	AFF	HEAT RECLAIM WATER HEATER	11014/1
ABOVE FINISH SLAB	AFS	HEAT RECLAIM WATER HEATER HEATING COIL	HRWH HC
AIR FILTER	AF	HEATING COIL HEATING AND VENTILATING UNIT	,,,
AIR COMPRESSOR	AC		HV HVAC
AIR COOLED CONDENSER	ACC	HEATING, VENTILATING & COOLING	
AIR HANDLING UNIT	AHU	HORSE POWER HOT WATER GENERATOR	HP
AMBIENT	AMB		HWG
AREA DRAIN	AD	HOT WATER STORAGE TANK HOSE BIBB	HWT
AUTOMATIC DAMPER	ADPR	11.555	HB
AUXILIARY ROOF DRAIN	ARD	HOSE STATION	HS
BACK DRAFT DAMPER	BD	HUMIDIFIER	Н
BOILER	В	INTAKE VENTILATOR	IV
BOILER FEED UNIT	BFU	INVERT	INV
BRITISH THERMAL UNITS	BTU	KILOWATTS	KW
CAPACITY	CAP	LEAVING AIR TEMPERATURE	LAT
CATCH BASIN	CB	LEAVING DRY BULB	LDB
CAST IRON	CI	LEAVING WATER TEMPERATURE	LWT
CEILING DIFFUSER	CD	LEAVING WET BULB	LWB
CHILLER	CH	LAVATORY	LAV
CIRCULATING PUMP	CP	LINEAR DIFFUSER	LD
CLEAN OUT	CO	MANHOLE	мн
CLEAN OUT TO GRADE	COTG	MAKE-UP AIR UNIT	MAU
CONVERTOR	C	MANUAL DAMPER	MD
CONDENSING UNIT	cn	MAXIMUM	MAX
CONNECT	CONN	MINIMUM	MIN
COOLING COIL	CC	MOTOR OPERATED DAMPER	MOD
COOLING TOWER	CT	MOUNTED	MTD
CARBON DIOXIDE	CO ₂	OPPOSED BLADE DAMPER	OBD
CUBIC FEET PER MINUTE	CFM	OUTSIDE AIR	OSA
COMB. FIRE, SMOKE DAMPER	FSDPR	PACKAGE TERMINAL AIR CONDITIONER	PTAC
CONDENSATE RETURN	CR	PLUMBING	PLBG
DAMPER	DPR	POUNDS PER SQUARE INCH	PSI
		PLUMBING FIXTURE	P
DESICCANT DEHUMIDIFIER	DD DTI	POWER ROOF VENTILATION	PRV
DOOR GRILLE	DG	PRESSURE DROP	PD
		REGISTER	REG
DOWN SPOUT DRY BULB	DS DB	RELATIVE HUMIDITY	RH
		RETURN AIR	RA
DRINKING FOUNTAIN	DF DHC	RETURN AIR GRILLE	RAG
DUCT HEATING COIL		REVOLUTIONS PER MINUTE	RPM
EFFICIENT	EFF EHC	ROOM AIR CONDITIONING UNIT	RAC
ELECTRIC HEATING COIL ELECTRIC WATER HEATER	ENC	ROOF DRAIN	RD
	-	SATURATED CONDENSING TEMPERATURE	SCT
ENERGY EFFICIENCY RATIO	EER	SATURATED SUCTION TEMPERATURE	SST
ENTERING AIR TEMPERATURE	EAT	SMOKE DAMPER	S.DPR
ENTERING DRY BULB	EDB	SPLITTER DAMPER	SD
ENTERING WATER TEMPERATURE	EWT	STAINLESS STEEL	SS
ENTERING WET BULB	EWB	STATIC PRESSURE	SP
EXTERNAL STATIC PRESSURE	ESP	STEAM	STM
EXHAUST	EXH	SUPPLY AIR	SA
EXHAUST FAN	EF.	SUPPLY FAN	SF
FEET PER MINUTE	FPM	TEMPERATURE	TEMP
FLOOR CLEANOUT	FCO	THERMOSTAT	T'STAT
FLOOR DRAIN	FD	THOUSAND BTU/PER HOUR	мвн
FAN	F	THREE WAY MODULATING VALVE	TWMV
FAN COIL UNIT	FCU	TOTAL STATIC PRESSURE	TSP
FINNED TUBE	FT	TOTAL DYNAMIC HEAD	TDH
FIRE DAMPER	F.DPR	UNIT COOLER	UC
FIRE/SMOKE DAMPER (COMBINATION)	FS.DPR	UNIT HEATER	UH
FLEXIBLE CONNECTION	FLEX CONN	UNIT VENTILATOR	UV
FLOOR	FLR	URINAL	UR
FLY FAN	FF	VENT THROUGH ROOF	VTR
REEZE PROOF WALL HYDRANT	FPWH	WATER HEATER	WH
REEZE PROOF BOX HYDRANT	FPBH	WALL CLEANOUT	WH WCO
FORWARD CURVE	FC	WATER CLOSET	WCO WCO
FURNACE	FU	WATER CLOSE I WATER PRESSURE DROP	WC WPD
GALLON	GAL	WATER PRESSURE DROP WATER TEMPERATURE DIFFERENCE	
GALLONS PER HOUR	GPH	WATER TEMPERATURE DIFFERENCE WATER TEMPERING VALVE	WTD WTV
GALLONS PER MINUTE	GPM	WATER TEMPERING VALVE WET BULB	WTV WB
GRAVITY ROOF VENTILATOR	GRV		



HVAC PIPING LEGEND SYMBOL **DESCRIPTION** --- R ---REFRIGERANT LINE SET ---- CD -----CONDENSATE DRAIN LINE

NOTE: ALL SYMBOLS MAY NOT BE USED.

HVAC GENERAL NOTES

- ALL WORK SHALL COMPLY WITH THE 2010 EDITION OF THE "ARKANSAS MECHANICAL CODE", THE 2011 EDITION OF THE "ARKANSAS ENERGY CODE", NFPA 90A, AND ALL STATE, CITY, AND LOCAL REQUIREMENTS.
- REFER TO ARCHITECTURAL PLANS FOR:
 REFLECTED CEILING PLAN FOR EXACT LOCATION OF AIR DEVICES AND CEILING
- EXACT LOCATIONS AND MOUNTING HEIGHTS OF EXTERIOR LOUVERS.
- FIRE RATED WALLS AND PARTITIONS. PROVIDE FIRE DAMPERS IN DUCT
 PENETRATIONS OF ALL FIRE RATED WALLS AND PARTITIONS AS NECESSARY TO MEET
 CITY AND STATE REQUIREMENTS.
 ALL WALL AND ROOF PENETRATIONS AND EQUIPMENT MOUNTING DETAILS.
- 3. ALL DUCT DIMENSIONS REPRESENT AIRFLOW AREA. INCREASE DUCT DIMENSIONS AS REQUIRED WHERE INTERNAL LINER IS SPECIFIED.
- ALL DUCTWORK SHALL BE CONSTRUCTED FROM GALVANIZED STEEL IN CONFORMANCE WITH SMACNA "HVAC DUCT CONSTRUCTION STANDARDS," LATEST EDITION.
- U.L. LISTED FLEXIBLE DUCT RUN-OUTS MAY BE USED, BUT SHALL NOT EXCEED 3:0" IN LENGTH. ALL FLEXIBLE DUCT TO BE PROPERLY SUPPORTED WITH NO KINKS OR HARD
- 6 DUCT FITTINGS:
- SUPPLY TAKE-OFFS TO CEILING SUPPLY DIFFUSERS TO BE 45" "SHOE" TAP.

 ALL DUCT RUN-OUTS TO HAVE 2" STAND-OFF LOCKING QUADRANT VOLUME DAMPERS

 ALL 90" ROUD ELBOWS TO HAVE R0-15 (QUILLESS OTHERWISE NOTED).

 ALL 90" RECTANGULAR ELBOWS TO HAVE TURNING VANES (UNLESS OTHERWISE
- PROVIDE HARD ELBOW WHEN TRANSITIONING FROM RIGID TO FLEXIBLE DUCT WHEN CONNECTING TO AIR DEVICES. REFER TO DETAIL
- ALL SUPPLY, RETURN, EXHAUST AND OUTSIDE AIR DUCTS SHALL BE EXTERNALLY WRAPPED WITH 2' FIBERGLASS WITH FOIL-SCRIM-KRAFT VAPOR BARRIER WHILE OUTSIDE THE MECHANICAL ROOM (UNLESS OTHERWISE NOTED).
- DUCTWORK TO BE COORDINATED WITH STRUCTURAL, ELECTRICAL, PLUMBING, AND FIRE PROTECTION, COMPONENTS AND SYSTEMS. ALL DUCTWORK THAT HAS TO BE OFFSET DUE TO AN OBSTRUCTION SHALL BE SLOPED WITH 2-45° ELBOWS UNLESS OTHERWISE NOTED.
- PROVIDE ACCESS PANELS IN CEILINGS OTHER THAN LAY-IN TYPE WHERE NECESSARY:

 PROVIDE 24"x24" ACCESS PANEL AT BALANCING DAMPERS, FIRE DAMPERS, CONTROLS, VALVES, TRAPS, CLEAN OUTS, ETC.

 - CLOSELY COORDINATE LOCATIONS AND SIZE OF ACCESS PANELS WITH INSTALLED
- EQUIPMENT TO ACHIEVE GREATEST ACCESSIBILITY FOR MAINTENANCE PURPOSES. PROVIDE 36"x24" ACCESS PANEL FOR EACH HEAT PUMP.
- PROVIDE ACCESS PANELS FOR GREASE DUCTS, AS REQUIRED BY NFPA 96, AT
- 12. COMPLETELY INSULATE THE TOPS OF ALL CEILING DIFFUSERS.
- 13. CLOSELY COORDINATE LOCATIONS OF INSTALLED EQUIPMENT TO ACHIEVE THE GREATEST
- MAINTAIN 10'-0" MINIMUM CLEARANCE BETWEEN OUTSIDE AIR INTAKES AND ALL EXHAUST FANS, FLUES, PLUMBING VENTS, ETC.
- 15. PROVIDE FLEXIBLE CONNECTIONS AT INLETS AND OUTLETS OF ALL AIR HANDLING UNITS, MAKE-UP AIR UNITS, FURNACES, AND/OR EXHAUST FANS.
- 16. ATTIC MOUNTED AND ABOVE CEILING MOUNTED EQUIPMENT SUBJECT TO
- WATER/CONDENSATE OVERFLOW SHALL BE SET IN DRAIN PANS WITH DRAINS TO THE OUTSIDE OR SANITARY SEWER SYSTEM WITH VISIBLE DISCHARGE
- CONDENSATE PIPING SHALL BE COMPRISED OF TYPE "M" COPPER TUBE, DWV COPPER, OR SCHEDULE 40 PVC.
- 18. PROVIDE APPROVED, NON-FLAMMABLE PIPE INSULATION ON ALL INSULATED PIPES AND PIPES OF PVC MATERIAL PASSING THRU AREAS OF BUILDING WITH RETURN AIR PLENUMS
- 19. THERMOSTATS TO BE MOUNTED 4'-0" ABOVE FINISHED FLOOR, MAX. THERMOSTATS IN "PUBLIC" AREAS TO HAVE LOCKING COVERS. COORDINATE WITH ARCHITECT.
- 20. SLEEVE AND SEAL ALL PIPE AND DUCT PENETRATIONS THROUGH FIRE RATED AND NON-RATED SLABS AND PARTITIONS.



BUILDING ARKANSAS STATE HIGHWAY AND TRANSPORTATION DEPARTMENT PARKING LOT & DEMONSTRATION E




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Issue Data Project Number 27-JANUARY-2014 2012-102 20 MECH. ABBREV'S. LEGENDS & GEN. NOTES

M-001



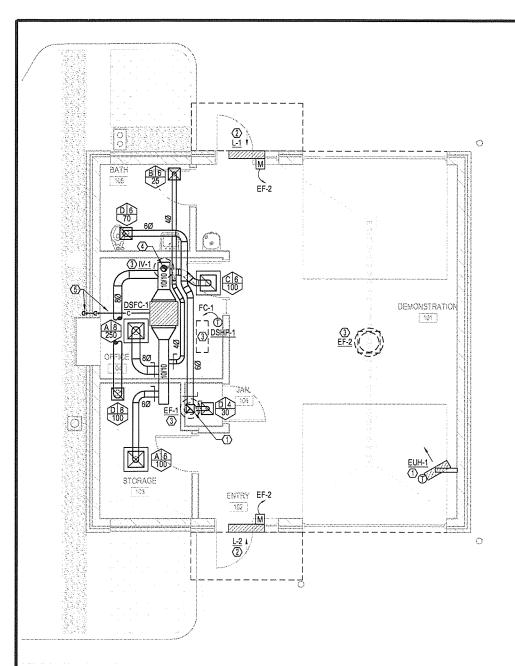

LEGEND AND NOTES

REFER TO SHEET M-001 FOR LEGEND AND NOTES.

MECHANICAL PLAN - KEYED NOTES

- $\ \, \bigoplus$ INSTALL THE UNIT HEATER AT 10' A.F.F. MEASURED TO THE BOTTOM OF THE HEATER.
- (2) INSTALL THE LOUVER ABOVE THE DOORWAY AND BENEATH THE CANOPY.
- (3) UNIT IS ROOF MOUNTED. PROVIDE AN EQUIPMENT STAND EQUAL TO A MIRO #LD MECHANICAL UNIT SUPPORT. COORDINATE THE EXACT SIZE REQUIRED WITH THE SIZE OF THE ROOFTOP HEAT PUMP. PROVIDE MIRO RECYCLED RUBBER O/E SUPPORT PADS BENEATH THE EQUIPMENT STAND BASES. ROUTE THE REFRIGERANT LINE SET, CONTROL CIRCUIT, AND POWER5 CIRCUIT THROUGH A COMMON ROOF PENETRATION (ROOF PENETRATION AND WEATHERPROOFING BY G.C.) TO THE INDOOR UNIT.
- (Z) 6" O.A. BRANCH DUCT WITH MANUAL BALANCING DAMPER FROM R.A. DUCT TO GRAVITY INTAKE VENTILATOR "IV-1" ON ROOF.
- (5) ROUTE A 3/4" TRAPPED REFRIGERANT CONDENSATE DRAIN LINE TO THE EXTERIOR WALL, DOWN IN THE WALL, OUT TO THE EXTERIOR AT 6" A.F.F., TURN DOWN AND TERMINATE WITH A BUG SCREEN.

	MINI-SPLIT HVAC SYSTEM													
М	ARK	SERVES	INDOOR UNIT TYPE	COOLING CAPACITY	HEATING CAPACITY	CFM (LO-M1-M2-HI)		ELECTRI	CAL	SEER	REFRIG.	MANUFACTURER	MODEL	DEMARKS
INDOOR	OUTDOOR	OLIVIEO	INDOOR DINT TITE	(BTUH)	(BTUH)	(BTUH) CFM (LO-M1-M2-HI) MCA MOCP VOLTS Ø		SEEK	REPRIG.	MANUFACTURER	MODEL	REMARKS		
DSFC-1	DSHP-1	OFFICE/RR/STOR	LOW-PROFILE DUCTED	12,000	16,000	350-390-420-490	0 13.4 15A 208 1				R-410A	FUJITSU	12RLFCD	SEE NOTES

- 1. S/S HEAT PUMP
- 2. PROVIDE INTEGRAL CONDENSATE PUMP KIT
- 3. PROVIDE LOW AMBIENT KIT DOWN TO 0°F
- 4. CFM IS WET COIL CONDITION
- 5. LOW VOLTAGE, WALL MOUNTED THERMOSTAT
- 6. INVERTER DRIVEN VAR. SPEED DC ROTARY COMPRESSOR
- 7. PROVIDE UNIT MOUNTED DISCONNECT 8. PROVIDE LIQUID LINE FILTER DRYER

9. OUTDOOR UNIT PROVIDES POWER TO INDOOR UNIT - COORDINATE THE ELECTRICAL REQUIREMENTS FOR BOTH THE INDOOR UNIT AND THE OUTDOOR UNIT WITH THE E.C. TO ENSURE THE INSTALLATION IS COMPLETE AND OPERATIVE

	EXHAUST FAN														
MARK	RK SERVES TYPE CONTROL				FAN DATA			MOTOR DATA			SONE		MANUFACTURER	MODEL	REMARKS
MICKES	VERTED	1116	CONTROL	DRIVE	DRIVE		POWER	VOLTS	Ø	LEVEL	WEIGHT (LBS)	MANUFACIURER	MODEL	REMARKS	
EF-1	BATH 105	DNFLOW CENTRIFUGAL	INTERLOCK WITH BATH 105 LIGHTS	DIRECT	100	1/8	1,550	1/60 HP	120	1	2.2	15	GREENHECK	G-060-D	NOTES 1-4
EF-2	EF-2 DEMONSTRATION 101 DNFLOW PROPELLER WALL SWITCH						1,750	1/2 HP	120	1	10.9	55	GREENHECK	AE-14-438-A5	NOTES 1-5

- 1. INTEGRAL DISCONNECT
- 2. GRAVITY BACKDRAFT DAMPER
- 3. 14" HIGH FACTORY CURB
- 4. FAN SPEED CONTROL FACTORY MOUNTED ON FAN HOUSING
- 5. INTERLOCK FAN OPERATION WITH INTAKE DAMPER ACTUATORS ON "L-1" AND "L-2".

UNIT HEATER - ELECTRIC											
MARK LOCATION	LOCATION	HEATING	CAPACITY		ELECT	RICAL DAT	ΓA			REMARKS	
	LOCATION	KW	MBH	CFM	FLA	VOLTS	Ø	MANUFACTURER	MODEL.		
EUH-1 DEMONSTRATION 101 11.2 38,400 700 31.3 208 3 RAYWALL HF3B5115CA1L SEE NOT											

- 2. PROVIDE A LINE VOLTAGE DOUBLE POLE THERMOSTAT WITH THERMOMETER EQUAL TO TPI ET5DTS
- 3. INDIVIDUALLY ADJUSTABLE LOUVERS
- 4. MOUNTED FOR HORIZONTAL DISCHARGE
- 5. WALL BRACKET EQUAL TO TPI A5100 (W/B5100 HEATER BRACKET)
- 6. WALL MOUNT AT 9' A.F.F.

					LOUVER				
MARK	SERVES	SERVICE	CFM	SIZE	FREE AREA (SQFT)	PRESSURE DROP (IN.)	MANUFACTURER	MODEL	REMARKS
L-1	EF-2	INTAKE AIR	750	36"x16"	0.88	0.05	GREENHECK	EACN-601	SEE NOTES
L-2	EF-2	INTAKE AIR	750	18"x18"	0.83	0.04	GREENHECK	EACN-601	SEE NOTES

- 1. COLOR AND FINISH PER ARCHITECT
- 2. FACTORY MOUNTED 120V DAMPER ACTUATOR
- 3. INTEGRAL BIRD SCREEN
- 4. DAMPER MOTOR SHALL BE INTERLOCKED WITH "EF-2" SUCH THAT THE DAMPER SHALL BE FULLY OPEN WHEN "EF-2" IS OPERATING AND VICE-VERSA.
- 5. EXACT LOCATION AND MOUNTING HEIGHT PER ARCHITECT


INTAKE VENTILATOR												
MARK	SERVES	TYPE	CFM	SP (IN WC)	THROAT SIZE (S.F.)	TOTAL UNIT WEIGHT (LBS)	MANUFACTURER	MODEL	REMARKS			
IV-1	DSFC-1 O.A.	LOW-PROFILE	70	0.05	0.37	10	GREENHECK	GRSI-8	SEE NOTES			

- PROVIDE MANUFACTURERS ROOF CURB
- 2. PROVIDE AN INTEGRAL 24V MOTORIZED O.A. DAMPER INTERLOCKED WITH THE DUCTLESS MINI-SPLIT SYSTEM OPERATION SUCH THAT THE DAMPER IS FULLY OPEN WHEN THE FAN COIL IS OPERATIONAL AND VICE-VERSA.

AIR DEVICES											
MARK	TYPE	DESCRIPTION	SIZE	NECK	INSTALLATION	MATERIAL	COLOR	MAX NC	MANUFACTURER	MODEL	REMARKS
Α	SUPPLY	SQUARE CONE	24x24	SEE PLANS	LAY-IN CLG	STEEL	WHITE	30	PRICE	SCD	SEE NOTES
В	SUPPLY	SQUARE CONE	12x12	SEE PLANS	LAY-IN CLG	STEEL	WHITE	30	PRICE	SCD	SEE NOTES
С	RET/EXH	EGGCRATE	24x24	SEE PLANS	LAY-IN CLG	STEEL	WHITE	30	PRICE	80	SEE NOTES
D	RET/EXH	EGGCRATE	12x12	SEE PLANS	LAY-IN CLG	STEEL	WHITE	30	PRICE	80	SEE NOTES

1. BORDER SHALL BE APPROPRIATE FOR INSTALLATION TYPE.

2. LAY-IN AIR GRILLES SHALL HAVE CORE SIZES AS SCHEDULED WITH SOLID PANEL BORDERS SIZED FOR THE GRID IN WHICH THEY ARE INSTALLED.

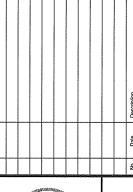





BUILDING ARKANSAS STATE HIGHWAY AND TRANSPORTATION DEPARTMENT PARKING LOT & DEMONSTRATION E






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MECHANICAL

M-101

PLAN

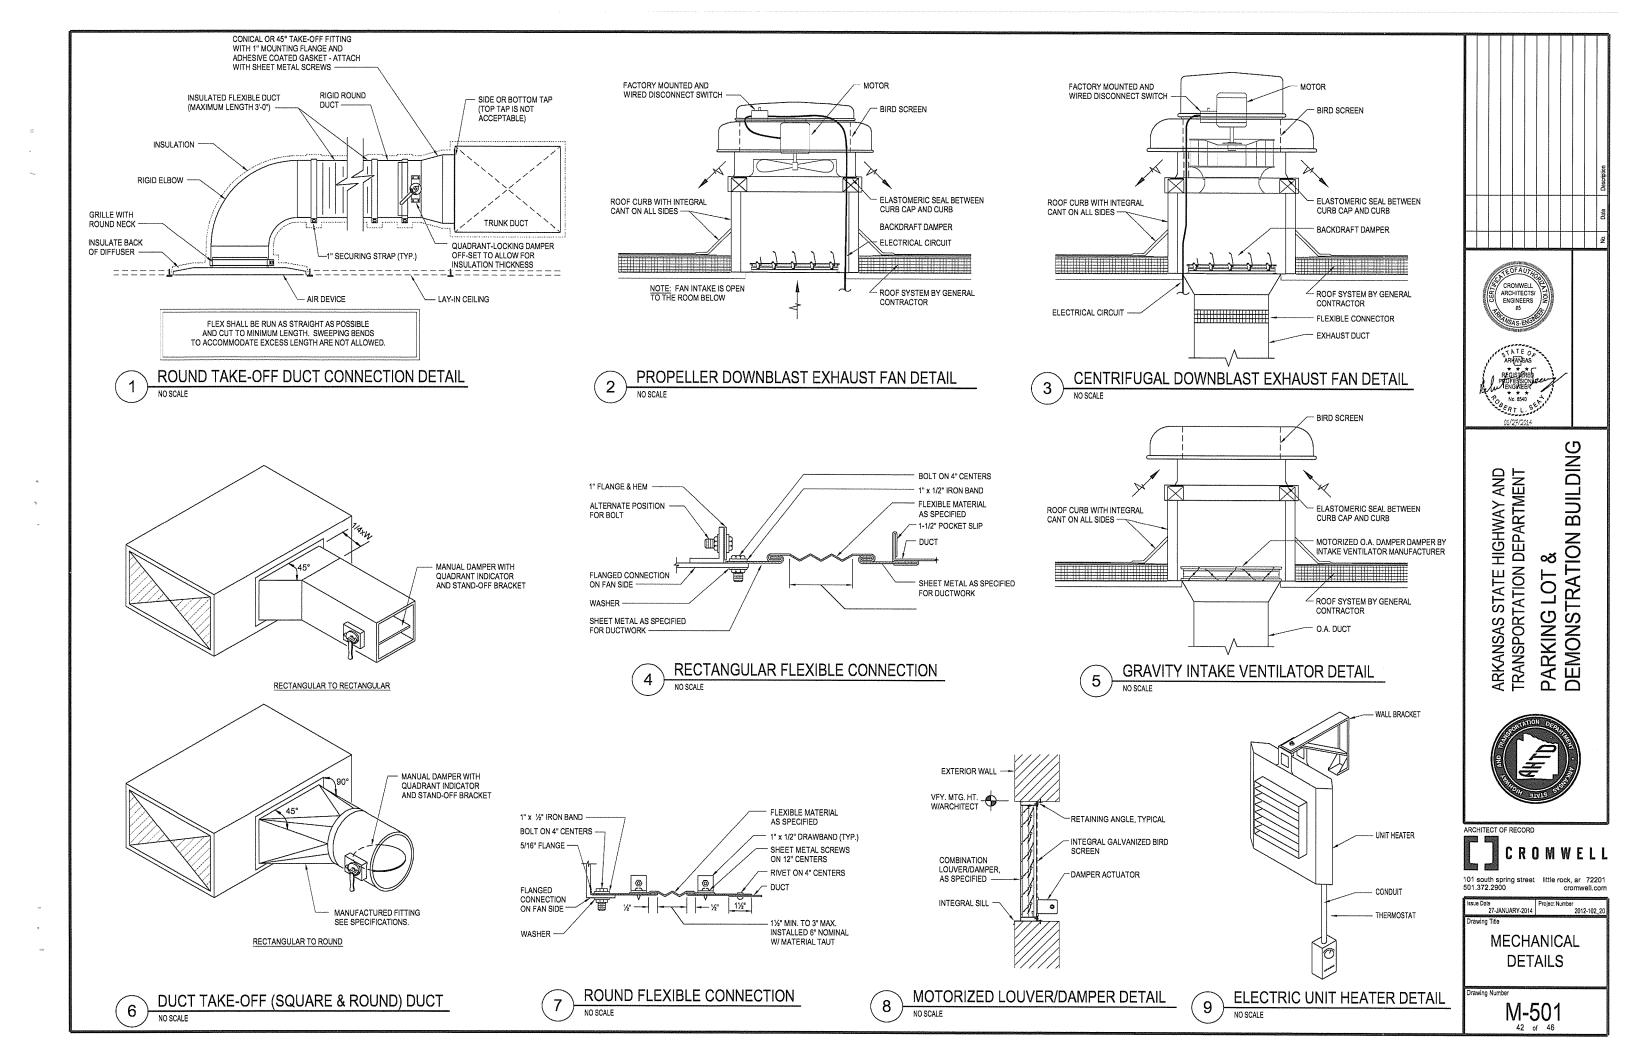

ELECTRICAL SYMBOLS

RECEPTACLES (MOUNTED 18" AFF UNLESS INDICATED OTHERWISE)

- DUPLEX RECEPTACLE OUTLET (20A, 125V, 2 POLE, 3 WIRE, GROUNDING TYPE, NEMA 5-20R)
- DUPLEX RECEPTACLE OUTLET (20A, 125V, 2 POLE, 3 WIRE, GROUNDING TYPE, NEMA 5-20R) MOUNT 4* ABOVE COUNTER TOP, SINK, OR BACKSPLASH (IF PRESENT).
- SINGLE RECEPTACLE OUTLET (20A, 125V, 2 POLE, 3 WIRE, GROUNDING TYPE, NEMA 5-20R)
- FLOOR RECEPTACLE OUTLET (20A, 125V, 2 POLE, 3 WIRE, GROUNDING TYPE, NEMA 5-20R)
- SINGLE RECEPTACLE OUTLET (20A, 250V, 2 POLE, 3 WIRE, GROUNDING TYPE, NEMA 6-20R)
- SINGLE RECEPTACLE OUTLET (30A, 250V, 2 POLE, 3 WIRE, GROUNDING TYPE, NEMA 6-30R)
- SINGLE SPECIAL-PURPOSE RECEPTACLE OUTLET; NUMBER CORRESPONDS TO THE SPECIAL-PURPOSE RECEPTACLE SCHEDULE.
- DUPLEX RECEPTACLE MOUNTED IN CEILING (20A, 125V, 2 POLE, 3 WIRE GROUNDING TYPE NEMA 5-20R)
- TWO (2) DUPLEX RECEPTACLES MOUNTED IN DOUBLE GANG BACKBOX (20A, 125V, 2 POLE, 3 WIRE GROUNDING TYPE NEMA 5-20R)
- TWO (2) DUPLEX RECEPTACLES FLOOR MOUNTED IN DOUBLE GANG BACKBOX (20A, 125V, 2 POLE, 3 WIRE GROUNDING TYPE NEMA 5-20R)

LIGHT FIXTURES

0

0

- O LIGHT FIXTURE, FLUORESCENT, CEILING MOUNTED.
 - LIGHT FIXTURE, FLUORESCENT, CEILING MOUNTED ON EMERGENCY CIRCUIT.
 - LIGHT FIXTURE, FLUORESCENT, CEILING MOUNTED WITH EMERGENCY SELF CONTAINED BATTERY PACK. BATTERY PACK IS TO REMAIN UNSWITCHED.
- LIGHT FIXTURE, FLUORESCENT, WALL MOUNTED.
- LIGHT FIXTURE, FLUORESCENT, INDUSTRIAL STRIP, SURFACE OR PENDANT MOUNTED.
- O LIGHT FIXTURE, INCANDESCENT, FLUORESCENT OR H.I.D., CEILING MOUNTED. (REFER TO FIXTURE SCHEDULE FOR TYPE).
- O* LIGHT FIXTURE, INCANDESCENT, FLUORESCENT OR H.I.D., WALL MOUNTED. (REFER TO FIXTURE SCHEDULE FOR TYPE).
- EMERGENCY BATTERY POWERED LIGHTING UNIT, WITH SELF CONTAINED BATTERY, CHARGER, ETC. (REFER TO FIXTURE SCHEDULE FOR BATTERY TYPE, VOLTAGE, LAMP TYPE, WATTAGE, ETC.) TRIANGLES DEPICT QUANTITY AND AIMING OF LAMP HEADS.
- EXIT SIGN, LIGHTED, CEILING MOUNTED. SHADED AREA INDICATES FACE. ARROW DEPICTS DIRECTIONAL ARROW ON SIGN. WHEN REQUIRED BY THE FIXTURE SCHEDULE, AN EMERGENCY SELF-CONTAINED BATTERY PACK IS TO REMAIN UNSWITCHED.
- EXIT SIGN, LIGHTED, WALL MOUNTED AT 7'-0" AFF UNLESS INDICATED OTHERWISE. WHEN REQUIRED BY THE FIXTURE SCHEDULE, AN EMERGENCY SELF-CONTAINED BATTERY PACK IS TO REMAIN UNSWITCHED.
- FLOOD LIGHT. ARROW INDICATES DIRECTION OF BEAM.

DOCK LIGHT

LIGHT FIXTURE IDENTIFICATION

A CONTROL (WHERE APPLICABLE)

- UPPER CASE LETTER BESIDE EACH FIXTURE DENOTES FIXTURE TYPE.

SWITCHGEAR

- MAGNETIC MOTOR STARTER (FURNISHED BY DIVISION 15, UNLESS NOTED OTHERWISE)
 - ELECTRICAL PANELBOARD, FLUSH MOUNTED
- ELECTRICAL PANELBOARD, SURFACE MOUNTED
- SAFETY SWITCH; 30A CURRENT RATING UNLESS NOTED OTHERWISE. +4'-0" TO
 - FUSIBLE SAFETY SWITCH; CURRENT RATING AND FUSE RATING NOTED. +4'-0" TO HANDLE.
- CIRCUIT BREAKER IN WALL MOUNTED ENCLOSURE

ELECTRICAL TRANSFORMER. FLOOR MOUNTED UNLESS INDICATED OTHERWISE

ELECTRICAL SYMBOLS

SWITCHES (MOUNTED AT 46", UNLESS INDICATED OTHERWISE)

- So SWITCH, SINGLE POLE, 20A; LOWER CASE LETTER INDICATES DEVICES
 - SWITCH, DOUBLE POLE, 20A SWITCH,
- 3-WAY, 20A SWITCH
 - 4-WAY, 20A SWITCH
- SINGLE POLE MANUAL MOTOR STARTING SWITCH, WITH THERMAL OVERLOAD ELEMENT AND PROVISIONS FOR LOCKING OPEN
- SWITCH, DIMMING (ON FLUORESCENT FIXTURES, COORDINATE WITH BALLAST MANUFACTURER)
- S_{LV}

 LOW VOLTAGE WITH MOMENTARY CONTACTS SWITCH.
 - OCCUPANCY SENSOR, COMBINATION ULTRASONIC SWITCH AND PASSIVE INFRARED
 - OCCUPANCY SENSOR, CEILING MOUNTED, COMBINATION ULTRASONIC AND PASSIVE INFRARED

MULTIPLE DEVICES LOCATED SIDE BY SIDE (OR ABOVE AND BELOW, IF DIFFERENT ELEVATIONS ARE SHOWN) AT THE LOCATION INDICATED).

SINGLE LINE

CIRCUIT BREAKER, TRIP RATING AS INDICATED, 3 POLE OR AS INDICATED.



+6' AFF

DISCONNECT SWITCH OR LOAD INTERRUPTER SWITCH, CURRENT RATING AS INDICATED, 3 POLE OR AS INDICATED.



SWITCH WITH GROUND FAULT INTERRUPTER



FUSE, CURRENT RATING AND TYPE WHEN INDICATED



TRANSFORMER, DESCRIPTION AS NOTED OR PER SCHEDULE

- CURRENT TRANSFORMER
- WH WATT-HOUR METER
- G GENERATOR

SECURITY

- M MAGNETIC ALARM SWITCH
 MD MOTION DETECTOR
- MD
 - CARD READER

ABBREVIATIONS:

AFF = ABOVE FINISHED FLOOR
AFL = ABOVE FINISHED LANDING
GFI = GROUND FAULT INTERRUPTER
IG = ISOLATED GROUND
UIO = UNLESS INDICATED OTHERWISE
WP = WEATHERPROOF CONSTRUCTION
OF/OI = OWNER FURNISHED / OWNER INSTALLED
CF/CI = CONTRACTOR FURNISHED / CONTRACTOR INSTALLED

GENERAL SYMBOLS NOTES:

- 1. ALL SYMBOLS MAY NOT BE USED.
- 2. MOUNTING HEIGHTS ARE ABOVE FINISHED FLOOR OR GRADE TO THE CENTER LINE OF THE OUTLET, DEVICE, ETC. UNLESS INDICATED OTHERWISE.
- 3. LARGE AMPACITY CIRCUIT DESIGNATION EXAMPLE: "4 SETS OF 3#500, #2500, #1/0G, 4"C MEANS IN EACH OF FOUR 4" CONDUITS INSTALL THREE 500 kCM CONDUCTORS, ONE 250 kCM NEUTRAL AND ONE #1/0 GROUND.

ELECTRICAL SYMBOLS

TELEPHONE/COMMUNICATIONS/DATA (OUTLETS SHALL BE MOUNTED 18" AFF UNLESS INDICATED OTHERWISE)

- TCOMBINATION VOICE/DATA OUTLET. OUTLET BOX WITH 3/4" C STUBBED ABOVE ACCESSIBLE CEILING SPACE AND PULL CORD.
- COMBINATION VOICE/DATA FLOOR OUTLET. OUTLET BOX WITH 3/4" C STUBBED ABOVE ACCESSIBLE CEILING SPACE AND PULL CORD.
 - 4'-0" HIGH x 3/4" THICK VARNISHED PLYWOOD BACKBOARD. SEE PLANS FOR LENGTH.

MISCELLANEOUS

- JUNCTION BOX. WALL MOUNT AS INDICATED. FINAL CONNECTION TO BE MADE BY ELECTRICAL CONTRACTOR.
- 10' BARE #6 COILED & EXOTHERMICALLY WELDED TO COLUMN
 - CONDUIT RUN, EXPOSED

FLEXIBLE CONDUIT

- ---- CONDUIT RUN, CONCEALED
 - FIRE ALARM

FACP

FIRE ALARM CONTROL PANEL

(<u>2</u>).

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MANUAL PULL STATION - RED TRIM, MOUNTING HEIGHT PER NFPA 72

SMOKE DETECTOR (P-PHOTOELECTRIC)


HEAT DETECTOR ABOVE CEILING (RoR-RATE OF RISE)



HORN STROBE - WALL MOUNTED, WHITE TRIM (CANDELA AS NOTED)

,cd S

STROBE - CEILING MOUNTED, WHITE TRIM (CANDELA AS NOTED)

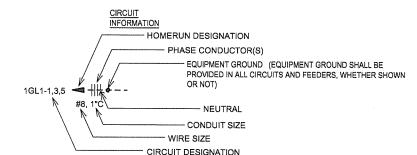

- CIRCUIT DESIGNATION INDICATES PANELBOARD AND CIRCUIT(S) TO WHICH HOMERUN IS CONNECTED.
- WIRE SIZE SHALL BE NO. 12, UNLESS INDICATED OTHERWISE.
- CONDUIT SIZE SHALL BE MINIMUM ALLOWED BY SPECIFICATIONS FOR NO. 12 SIZE WIRE, 3/4" FOR NO. 10, UNLESS INDICATED OTHERWISE.
- CIRCUIT INFORMATION PROVIDED AT THE HOMERUN SYMBOL SHALL APPLY THE ENTIRE LENGTH OF THE CIRCUIT (FROM PANELBOARD TO LAST LOAD).

   WHEN NO PHASE CONDUCTOR OR NEUTRAL IS INDICATED AT THE HOMERUN

SYMBOL, PROVIDE ONE PHASE CONDUCTOR AND ONE NEUTRAL, BOTH NO. 12.

- SWITCHING CONDUCTORS, CONDUCTORS FOR NIGHT LIGHT CIRCUITS (UNSWITCHED), ETC. ARE NOT SHOWN, BUT SHALL BE PROVIDED AS
- WIRE SIZE INDICATED ON THESE DOCUMENTS AS INDICATED BY "NO." OR "#"
  HAS THE SAME MEANING AS "AWG" (N.E.C. NOMENCLATURE). (i.e. "NO. 12" OR
  "#12" MEANS "12AWG" IN N.E.C. NOMENCLATURE.)







ARKANSAS STATE HIGHWAY AND TRANSPORTATION DEPARTMENT PARKING LOT & DEMONSTRATION BUILDING



ARCHITECT OF RECORD

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Drawing Title ELECTRICAL

LEGEND

E-001

# DEMONSTRATION


LIGHTING PLAN


SCALE: 1/4" = 1'-0"

# 1 POWER & SYSTEMS PLAN 1/4" = 1'-0" SCALE: 1/4" = 1'-0"

# **ELECTRICAL PLAN - KEYED NOTES**

- 1) INTERLOCK WITH BATHROOM LIGHTING CIRCUIT
- (2) MOUNT TRANSFORMER ABOVE PANEL. USE MANUFACTURER'S REQUIREMENTS FOR MOUNTING.
- (3) DSHP-1 IS LOCATED ON ROOF. COORDINATE WITH MECHANICAL. INDOOR UNIT IS POWERED FROM OUTDOOR UNIT. LOCATE WEATHERPROOF/GFI RECEPTACLE SHOWN ON A-17 WITHIN 25 FEET OF DSHP-1. COORDINATE ROUTING OF POWER FOR RECEPTACLE WITH POWER FOR DSHP-1 AND INDOOR UNIT (DSFC-1).

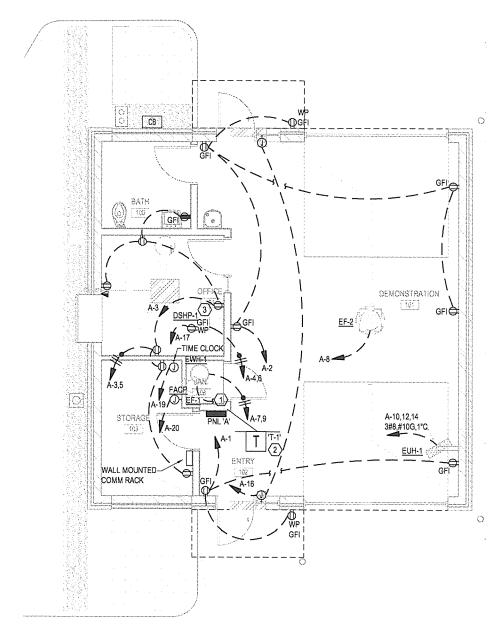

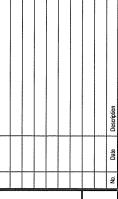





ARKANSAS STATE HIGHWAY AND TRANSPORTATION DEPARTMENT PARKING LOT & DEMONSTRATION BUILDING



ARCHITECT OF RECORD

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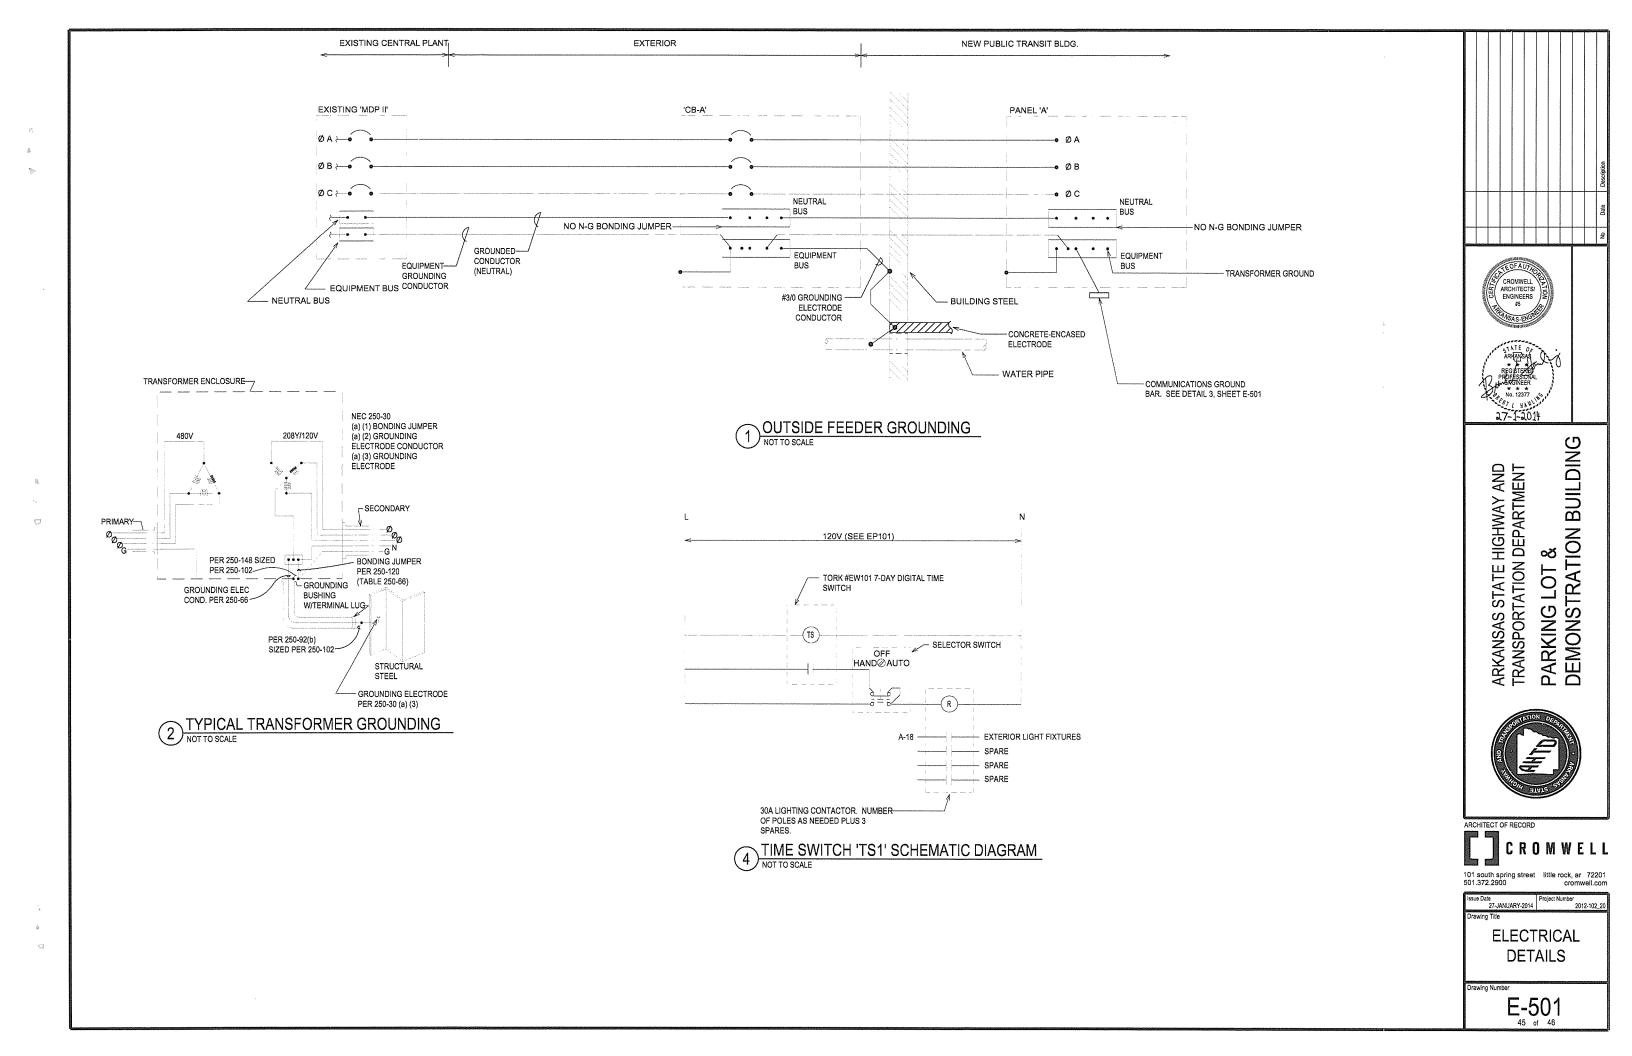
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Issue Date 27-JANUARY-2014 Project Number 2012-102\_20
Drawing Title

ELECTRICAL PLANS

Drawing Number

E-101



| ٧    | Panel<br>Main<br>Oltage | 208\   | /120    | POLES                   | S <u>SURFA</u><br>S 1<br>E 3 |    |       | LOCATION_<br>225 | 101   | TRIP<br>Mi | 175<br>NIMUM BF | MAIN BUS RATII<br>REAKER INTERRUPTING CAPACI |      | 25<br>KAIC | AMPS             |      |
|------|-------------------------|--------|---------|-------------------------|------------------------------|----|-------|------------------|-------|------------|-----------------|----------------------------------------------|------|------------|------------------|------|
|      | DEVICE                  | 110020 | 0011120 | BRANCH CIRCUIT          | ~                            |    | P     | HASE LOAD        |       |            |                 | BRANCH CIRCUIT                               |      |            | DEVICE           |      |
| AMPS | T                       |        |         | Divitori ontogri        | VOLT                         |    | 1 .   | OLTAMOS          |       |            | VOLT            |                                              |      |            |                  | AMPS |
| TRIP | POLES                   | TYPE   | LOAD    | DESCRIPTION             | AMPS                         | NO | A     | В                | С     | NO         | AMPS            | DESCRIPTION                                  | LOAD | TYPE       | POLES            | TRIP |
| 20   | 1                       |        |         | EXTERIOR RECPT, 101,102 | 540                          | 1  | 1440  |                  |       | 2          | 900             | EXTERIOR RECPT 101,102                       | R    |            | 1                | 20   |
| 20   | 1                       |        |         | RECEPTS 104,105         | 720                          | 3  |       | 1800             |       | 4          | 1080            | DSHP-1                                       | Н    |            | 2                | 20   |
| 20   | 1                       |        | R       | RECPTS 104,103          | 540                          | 5  |       |                  | 1620  | 6          | 1080            |                                              | Н    |            | -                |      |
| 20   | 2                       |        | М       | EWH-1                   | 1250                         | 7  | 2426  |                  |       | 8          | 1176            | EF-2                                         | Н    |            | 1                | 25   |
|      | -                       |        | M       |                         | 1250                         | 9  |       | 4983             |       | 10         | 3733            | EUH-1                                        | Н    |            | 3                | 40   |
| 20   | 1                       |        | L       | LIGHTS 101,102          | 546                          | 11 |       |                  | 4279  | 12         | 3733            |                                              | Н    |            |                  | -    |
| 20   | 1                       |        | L       | LIGHTS 103,104,105,106  | 283                          | 13 | 4016  |                  |       | 14         | 3733            |                                              | Н    |            | -                |      |
| 20   | 1                       |        |         | SPARE                   |                              | 15 |       | 400              |       | 16         | 400             | MOTORIZED LOUVERS                            | Н    |            | 1                | 20   |
| 20   | 1                       |        | R       | ROOF                    | 180                          | 17 |       |                  | 500   | 18         | 320             | EXTERIOR LIGHTING                            | L    |            | 11               | 20   |
| 20   | 1                       |        | М       | TIME CLOCK              | 200                          | 19 | 1400  |                  |       | 20         | 1200            | FIRE ALARM PANEL                             | M    |            | 11               | 20   |
| 20   | 1                       |        | M       | GATE                    | 1200                         | 21 |       | 1200             |       | 22         |                 | SPARE                                        |      |            | 1                | 20   |
| 45   | 3                       |        |         | GRINDER PUMP            | 2004                         | 23 |       |                  | 2004  | 24         |                 | SPARE                                        |      |            | 11               | 20   |
| -    | -                       |        |         |                         | 2004                         | 25 | 2004  |                  |       | 26         |                 | SPARE                                        |      |            | 1                | 20   |
|      | -                       |        |         |                         | 2004                         | 27 |       | 2004             |       | 28         |                 | SPARE                                        |      |            | 1                | 20   |
| 45   | 3                       |        |         | GRINDER PUMP            | 2004                         | 29 |       |                  | 2004  | 30         |                 | SPARE                                        |      |            | 1                | 20   |
|      | -                       |        |         |                         | 2004                         | 31 | 2004  |                  |       | 32         |                 | SPACE                                        |      |            | 1                | 20   |
| -    |                         |        |         |                         | 2004                         | 33 |       | 2004             |       | 34         |                 | SPACE                                        |      | ļ          | 1_1_             | 20_  |
| 20   | 1                       |        |         | SPACE                   |                              | 35 |       |                  |       | 36         |                 | SPACE                                        |      |            | 1                | 20   |
| 20   | 1                       |        |         | SPACE                   | L                            | 37 |       |                  |       | 38         |                 | SPACE                                        |      | ļ          | 11               | 20   |
| 20   | 1                       |        |         | SPACE                   | 1                            | 39 | ļ     |                  |       | 40         |                 | SPACE                                        |      | ļ          | 11               | 20   |
| 20   | 11                      |        |         | SPACE                   | 1                            | 41 | L     |                  |       | 42         | L               | SPACE                                        |      | 11120      | 1 1              | 20   |
|      |                         |        |         |                         | TOTAL                        |    | 13290 | 12391            | 10407 |            |                 | KVA (CONNECTED)<br>KVA (DEMAND)              |      |            | CONNEC<br>DEMAND |      |


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|------------------------------------------------------------------------------------------------------------------------------------------------------|---------------------------|--------------|---------------------------------|-------|----------|--------------------------------------------------------------------------------------|----------|--|--|--|--|--|--|--|
| <u>LEGEND</u> MAIN                                                                                                                                   | LIGHTING FIXTURE SCHEDULE |              |                                 |       |          |                                                                                      |          |  |  |  |  |  |  |  |
| CB = CIRCUIT BREAKER<br>LO = LUGS ONLY                                                                                                               | TYPE                      | MANUFACTURER | CATALOG NUMBER                  | VOLTS | LAMPS    | DESCRIPTION                                                                          | 1        |  |  |  |  |  |  |  |
| BRANCH CIRCUIT BREAKER TYPE  A = ARC FAULT CIRCUIT INTERRUPTER  G = GROUND FAULT CIRCUIT INTERRUPTER  S = SHUNT TRIP  V = VARIABLE (ADJUSTABLE TRIP) | A                         | METALUX      | 2GC8-232A125-UNV-ER81-PAF-U     | 120   | 2-32WT8  | 2X4 RECESSED LENSED PRISMATIC<br>TROFFER                                             |          |  |  |  |  |  |  |  |
| E = EQUIPMENT GROUND FAULT PROTECTION  LOAD TYPE L = LIGHTING                                                                                        | A1                        | METALUX      | 2EP3GX-432S481-PAF-U            | 120   | 4-32WT8  | 2X4 RECESSED LENSED PRISMATIC<br>TROFFER                                             |          |  |  |  |  |  |  |  |
| R = RECEPTACLE H = HVAC M = MISCELLANEOUS V = VARIOUS                                                                                                | В                         | METALUX      | BE-117-UNV-EB81                 | 120   | 1-F17T8  | 2' LOW PROFILE WALL BRACKET<br>MOUNTED AT 7'-6" AFF                                  |          |  |  |  |  |  |  |  |
| MISCELLANEOUS SN = SOLID NEUTRAL EQP GND = EQUIPMENT GROUND BUS IG = INSULATED GROUND BUS                                                            | С                         | METALUX      | 4VT3-332DR-UNV-EL-B50-ER81-WL-U | 120   | 3-32WT8  | 1X4 INDUSTRIAL STRIP CHAIN OR CABLE<br>HUNG AT 12-0" AFF W REMOTE BATTERY<br>BACK UP |          |  |  |  |  |  |  |  |
| SPD = SURGE PROTECTIVE DEVICE                                                                                                                        | D                         | TMS LIGHTING | P6U-2x CF32W PL-T-120V-F??-TGL6 | 120   | 1-32WCFL | WALL MOUNTED DIRECT/INDIRECT                                                         | <u> </u> |  |  |  |  |  |  |  |


P8W-CF32W-PLT-120V-F??-BGL8

LIGHTING FIXTURE SCHEDULE GENERAL NOTES:

TMS LIGHTING

1. PROVIDE FLANGE KITS AND ACCESSORIES AS REQUIRED.

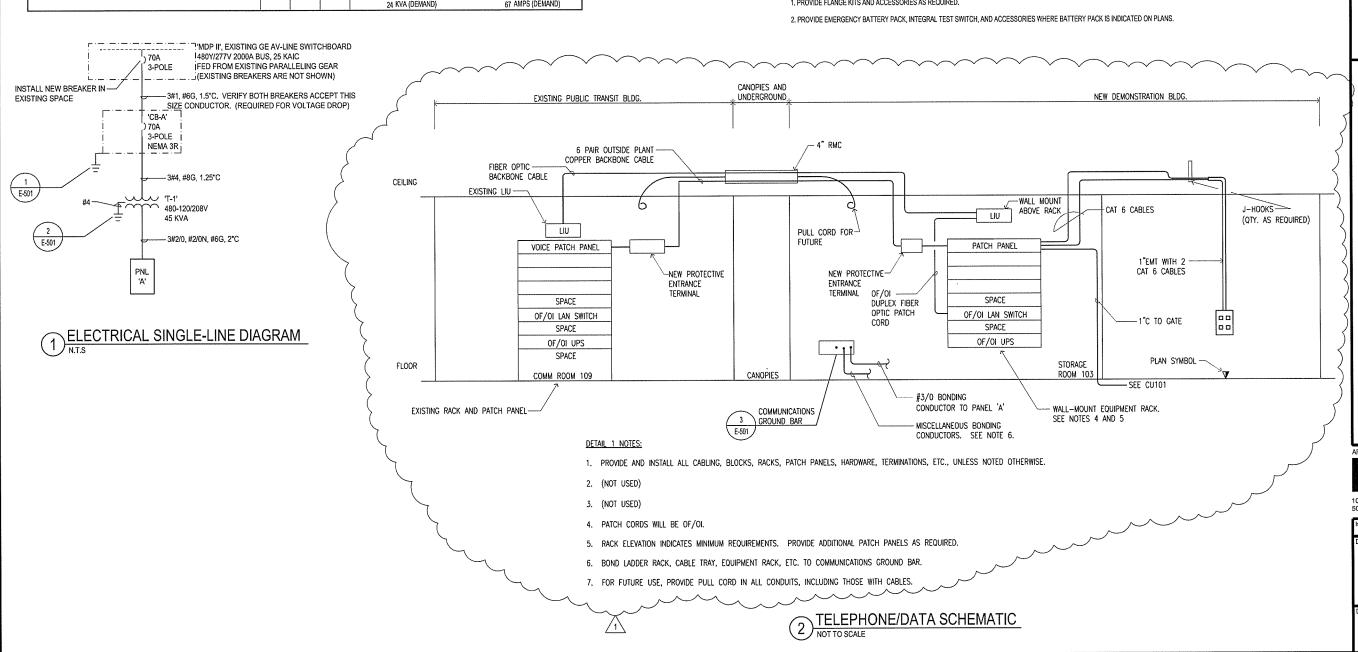

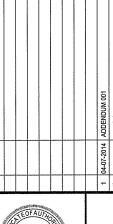

NOTES

WALL MOUNTED SCONCE

120

1-32WCFL





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e Date P 27-JANUARY-2014 '<sup>™</sup>SINGLE-LINE DIAGRAM & **SCHEDULES** 

E-601